CASAS DEL RIO

26 NEW TOWNHOUSES - AFFORDABLE HOUSING

CAMDEN LUTHERAN HOUSING INC. 800 GALINDEZ CT. CAMDEN, NJ 08102

DRAWING INDEX COVER SHEET, ZONING ANALYSIS, BUILDING CODE INFORMATION, NOTES, 200' RADIUS MAP, LOCATION MAP, DRAWING INDEX C-100 SITE DEMOLITION PLAN C-101 OVERALL SITE PLAN C-102 SITE DETAILS 1 C-103 SITE DETAILS 2 BLOCK #804 DETAILED SITE PLAN BLOCK #805 DETAILED SITE PLAN C-301 BLOCK #804 UTILITY PLAN C-302 BLOCK #805 UTILITY PLAN C-303 UTILITY DETAILS LANDSCAPE PLAN, NOTES & DETAILS SESC-101 SOIL EROSION & SEDIMENT CONTROL PLAN SESC-102 SOIL EROSION & SEDIMENT CONTROL DETAILS A-010 ARCHITECTURAL RENDERING VIEW ALONG N. 10th STREET A-020 BUILDING / STREET ELEVATIONS UNIT #1: PROPOSED FLOOR PLANS UNIT #1: BUILDING ELEVATIONS A-101 A-102 UNIT #1: BUILDING MATERIALS UNIT #2: PROPOSED FLOOR PLANS & ELEVATIONS A-200 UNIT #2: BUILDING MATERIALS UNIT #3: PROPOSED FLOOR PLANS & ELEVATIONS

SURVEY

PROPOSED SITE PLAN INFORMATION BASED ON SURVEY DATED 03/15/2024 & MAJOR SUBDIVISION PLAN DATED 03/17/24 PERFORMED BY RWC SURVEYING, WITH ADDRESS P.O. BOX 3652 TOMS RIVER, NJ 08756, TEL. (888)676-4435.

PROJECT DESCRIPTION & SUMMARY


UNIT #3: BUILDING MATERIALS

THE PROPOSED PROJECT INCLUDES THE NEW CONSTRUCTION OF 26 TOWNHOUSES AS AFFORDABLE HOUSING ON TWO VACANT BLOCKS.

BLOCK #804

PROPOSED LOTS 1 THROUGH 13 x 1,969 SF (EACH LOT) = 25,600 SF TOTAL AREA

BLOCK #805
PROPOSED LOTS 1 THROUGH 13 x 1,969 SF (EACH LOT) = 25,600 SF TOTAL AREA

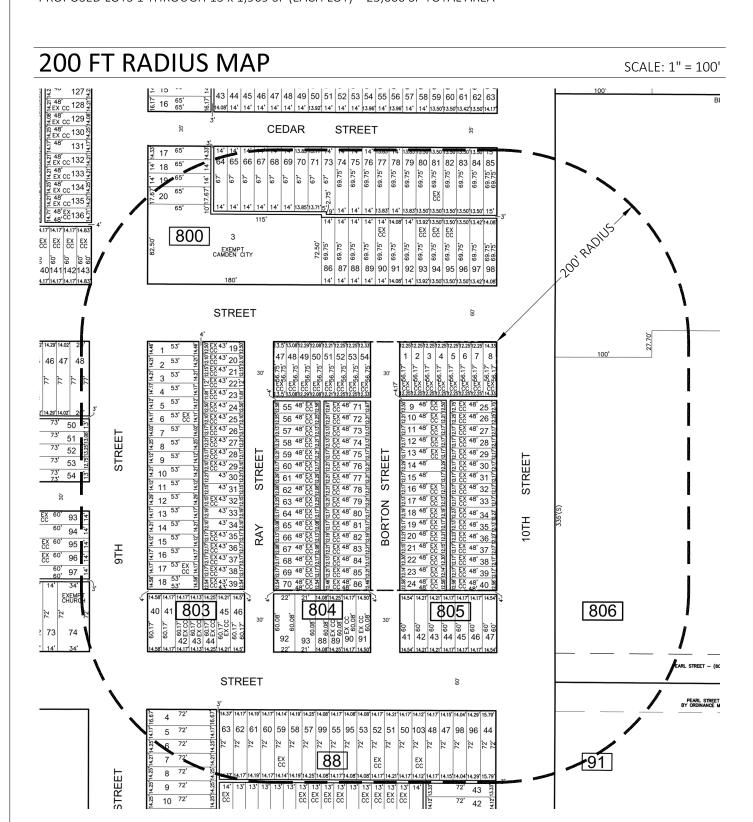


ZONING ANALYSIS REQUIRED UNDER PROPOSED VARIANCE R-2 RESIDENTIAL DISTRICT ORDINANCE SINGLE FAMILY RESIDENTIAL REQUIRED BLOCK #804: LOTS #1 THRU #13 | BLOCK #805: LOTS #1 THRU #13 | PERMITTED PRINCIPAL USE TOWNHOUSE **TOWNHOUSE** ATTACHED DWELLINGS ATTACHED DWELLINGS MINIMUM LOT AREA 2,000 SF YES 1,972 SF AT LOTS #1 MAXIMUM LOT AREA 3,000 SF 1,969 SF 1,972 SF AT LOTS #1 YES MINIMUM LOT WIDTH 20 FT 19.72 FT AT LOTS #1 MINIMUM LOT DEPTH 100 FT 3 STORIES OR 35 FT MAXIMUM HEIGHT 2 STORIES NO 27.6 FT MINIMUM FRONT YARD SETBACK 10 FT 9 FT AT LOTS #1, 5, 9 & 13 YES AT LOTS #1, 5, 9 & 13 MINIMUM AGGREGATE WIDTH OF N/A N/A N/A SIDE YARDS MINIMUM WIDTH OF EACH SIDE O FT AT INTERIOR LOTS O FT AT INTERIOR LOTS 10 FT END OF CORNER LOTS O FT AT CORNER LOTS YES AT LOTS #1 MINIMUM DEPTH OF REAR YARD 40.5 FT MAXIMUM LOT BUILDING 49% NO COVERAGE MAXIMUM LOT IMPERVIOUS 80% COVERAGE OFF-STREET PARKING 2 SPACES FOR 3-BEDROOM 1 SPACE PROVIDED UNIT OR A FRACTION THEREOF NOT TO EXCEED 20 FT IN 20 FT - COMBINED DRIVEWAYS DRIVEWAYS 10 FT - SINGLE DRIVEWAY WIDTH STREET TREES SPACED NO NEW TREE SPACING AT 35 FT & LANDSCAPING GREATER THAN 40 FT ON

FLOOD NOTES

THE PROJECT LOCATION IS <u>NOT</u> LOCATED IN A DESIGNATED FLOOD HAZARD ZONE AS PER FEMA FLOOD INSURANCE RATE MAP No. 34007C0028F, DATED AUGUST 17, 2016.

CENTER

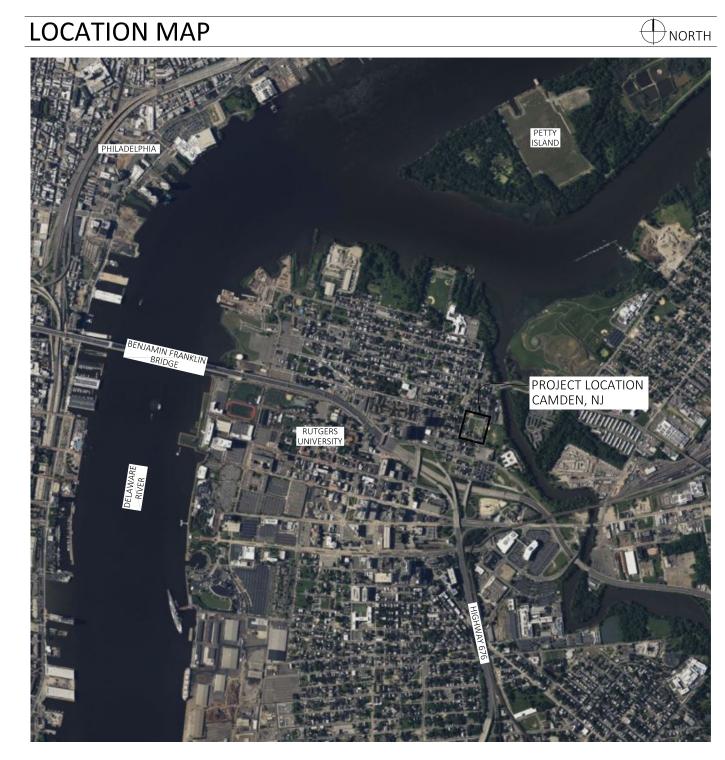

APPLICABLE CODES 2021 INTERNATIONAL BUILDING CODE - NJ EDITION 2021 INTERNATIONAL RESIDENTIAL CODE - NJ EDITION 2021 NATIONAL STANDARD PLUMBING CODE - NJ EDITION 2020 NATIONAL ELECTRICAL CODE (NFPA 70) 2021 INTERNATIONAL ENERGY CONSERVATION CODE 2021 INTERNATIONAL MECHANICAL CODE 2021 INTERNATIONAL FUEL GAS CODE 2021 ICC A117.1 BARRIER FREE CODE

PROJECT & BUILDING CODE INFORMATION					
BLOCK & LOT:	BLOCK 804, LOTS #1 THRU #13				
	BLOCK 805. LOTS #1 THRU #13				
EXISTING USE:	VACANT LAND				
PROPOSED WORK:	CONSTRUCTION OF 26 NEW TOWNHOUSES				
ZONING:	R-2 RESIDENTIAL				
BUILDING OCCUPANCY CLASSIFICATION:	R-5 SINGLE-FAMILY TOWNHOUSES NOT MORE THAN THREE STORIES IN HEIGHT WITH A SEPARATE MEANS OF EGRESS				
BUILDING CONSTRUCTION CLASSSIFICATION:	V-B				
	PERMITTED	PROPOSED			
AREA PER FLOOR:	4,800 SF	1,010 SF			
BUILDING OCCUPANCY:	200 SF PER PERSON	9 TOTAL OCCUPANTS			
BUILDING HEIGHT:	35 FT 2 STORIES	27.6 FT 2 STORIES			
AUTOMATIC SPRINKLER SYSTEM:	NFPA 13D SPRINKLER SYSTEM TO	BE INSTALLED THROUGHOUT			

FIRE RESISTANCE RATINGS TABLE 601 FIRE RESISTANCE RATING REQUIREMENTS FOR BUILDING ELEMENTS (HOURS) PRIMARY STRUCTURAL FRAME: 0 HRS **BEARING WALLS** EXTERIOR - TABLE 705.5 (LESS THAN 5 FT FROM PROPERTY LINE): 0 HRS NON-BEARING WALLS & PARTITIONS (EXTERIOR - TABLE 705.5): 1 HR NON-BEARING WALLS & PARTITIONS (INTERIOR): 0 HRS FLOOR CONSTRUCTION & ASSOCIATED SECONDARY STRUCTURAL MEMBERS: 0 HRS ROOF CONSTRUCTION & ASSOCIATED SECONDARY STRUCTURAL MEMBERS: 0 HRS COMMON WALLS SEPARATING TOWNHOUSES (R302.2.2): 1 HR

APPROVAL	SIGNATURES

BOARD CHAIRPERSON	 DATE
BOARD SECRETARY	DATE
ZONING OFFICER	DATE
BOARD CITY ENGINEER	DATE



CAMDEN LUTHERAN HOUSING INC.

rchitect

Milla Architecture Studio 137 Lake Road Valley Cottage, NY 10989

Civil Engineer

JENNE ASSOCIATES, LLC Consulting Engineers 35 Gates Avenue Warren, NJ 07059

DATE	ISSUE	DESCRIPTION
06/28/24	1	PLANNING BD. SUBMISSION

It is a violation of the law for any person, unless acting under the direction of a licensed architect, to alter this item in any way.

Proje

CASAS DEL RIO
CAMDEN LUTHERAN HOUSING INC.
NORTH CAMDEN, NJ

Drawing Title

COVER SHEET, ZONING ANALYSIS, BUILDING CODE INFORMATION, NOTES, 200' RADIUS MAP, LOCATION MAP & DRAWING INDEX

Drawing No.


C-01

MICHAEL I. MILLA

Project No.
23-014

Scale
AS NOTED

Drawn/Checked by NS/MM

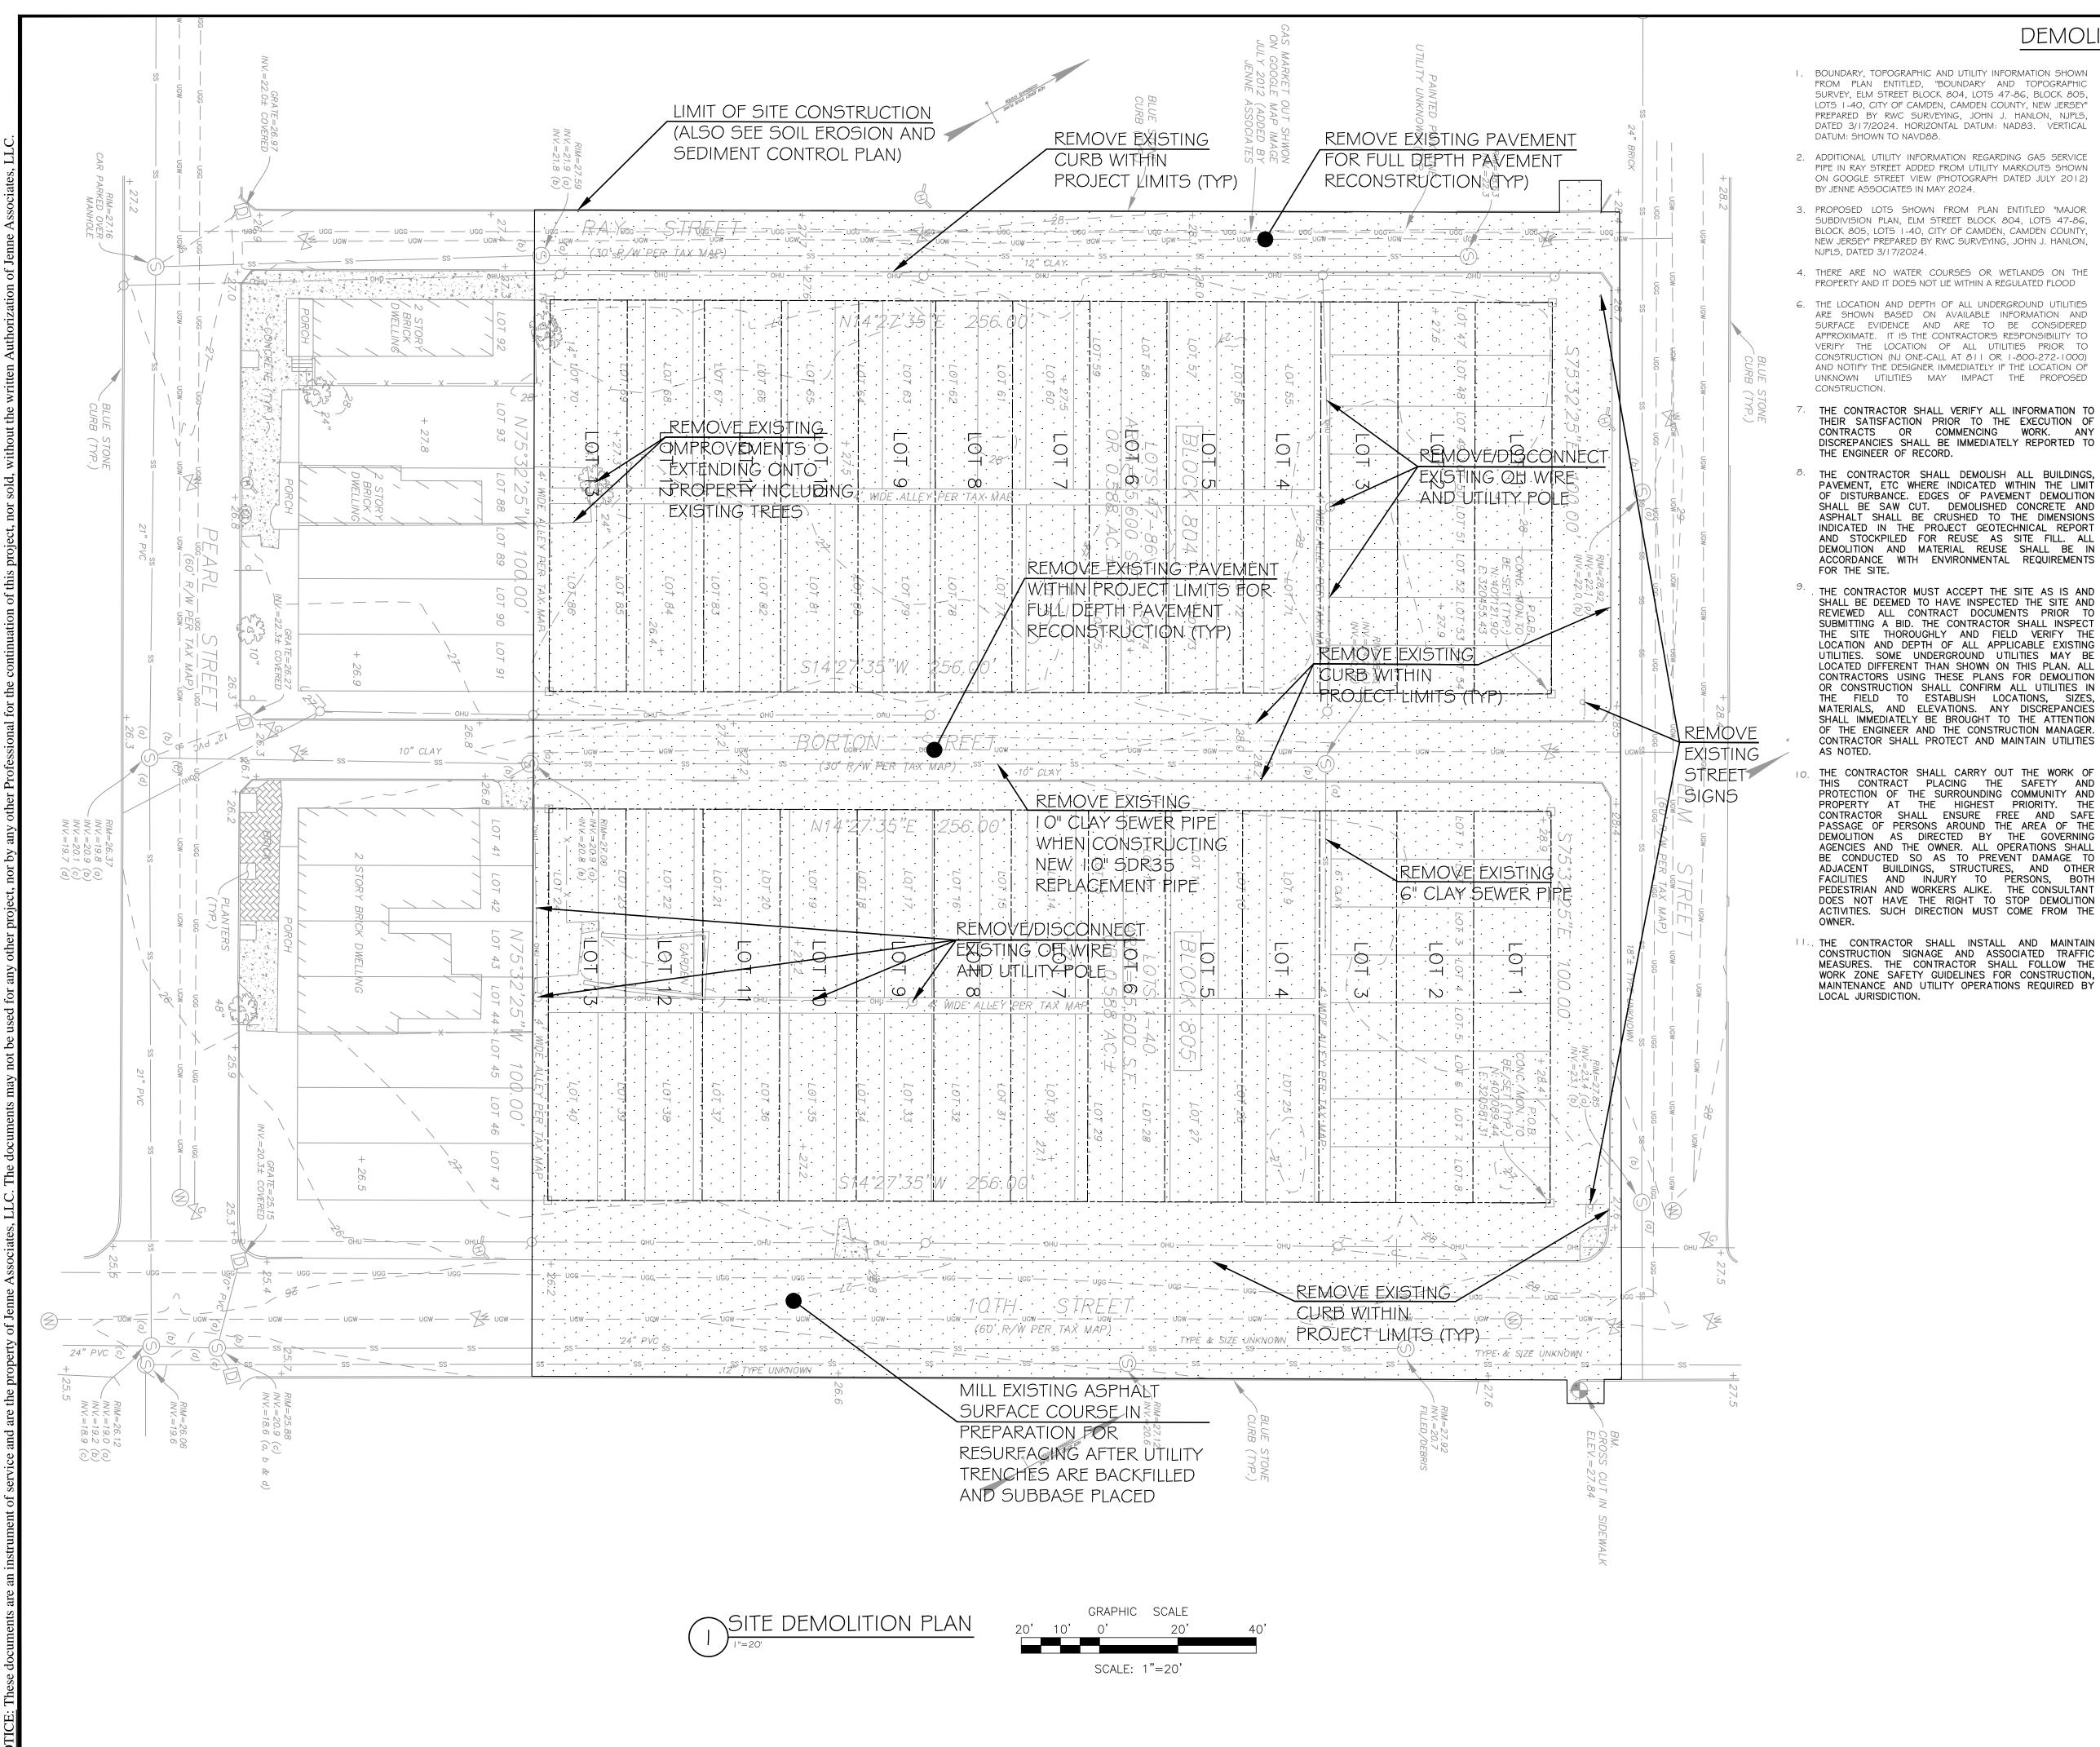

DEMOLITION NOTES

I. BOUNDARY, TOPOGRAPHIC AND UTILITY INFORMATION SHOWN 12. THE CONTRACTOR SHALL BE SOLELY RESPONSIBLE FOR FROM PLAN ENTITLED, "BOUNDARY AND TOPOGRAPHIC SURVEY, ELM STREET BLOCK 804, LOTS 47-86, BLOCK 805, LOTS 1-40, CITY OF CAMDEN, CAMDEN COUNTY, NEW JERSEY" PREPARED BY RWC SURVEYING, JOHN J. HANLON, NJPLS, DATED 3/17/2024. HORIZONTAL DATUM: NAD83. VERTICAL DATUM: SHOWN TO NAVD88.

- 2. ADDITIONAL UTILITY INFORMATION REGARDING GAS SERVICE PIPE IN RAY STREET ADDED FROM UTILITY MARKOUTS SHOWN ON GOOGLE STREET VIEW (PHOTOGRAPH DATED JULY 2012) BY JENNE ASSOCIATES IN MAY 2024.
- 3. PROPOSED LOTS SHOWN FROM PLAN ENTITLED "MAJOR SUBDIVISION PLAN, ELM STREET BLOCK 804, LOTS 47-86, BLOCK 805, LOTS 1-40, CITY OF CAMDEN, CAMDEN COUNTY, NEW JERSEY" PREPARED BY RWC SURVEYING, JOHN J. HANLON, NJPLS, DATED 3/17/2024.
- 6. THE LOCATION AND DEPTH OF ALL UNDERGROUND UTILITIES ARE SHOWN BASED ON AVAILABLE INFORMATION AND SURFACE EVIDENCE AND ARE TO BE CONSIDERED APPROXIMATE. IT IS THE CONTRACTOR'S RESPONSIBILITY TO VERIFY THE LOCATION OF ALL UTILITIES PRIOR TO CONSTRUCTION (NJ ONE-CALL AT 811 OR 1-800-272-1000) AND NOTIFY THE DESIGNER IMMEDIATELY IF THE LOCATION OF UNKNOWN UTILITIES MAY IMPACT THE PROPOSED
- THE CONTRACTOR SHALL VERIFY ALL INFORMATION TO THEIR SATISFACTION PRIOR TO THE EXECUTION OF CONTRACTS OR COMMENCING WORK. ANY DISCREPANCIES SHALL BE IMMEDIATELY REPORTED TO THE ENGINEER OF RECORD.
- PAVEMENT, ETC WHERE INDICATED WITHIN THE LIMIT OF DISTURBANCE. EDGES OF PAVEMENT DEMOLITION SHALL BE SAW CUT. DEMOLISHED CONCRETE AND ASPHALT SHALL BE CRUSHED TO THE DIMENSIONS INDICATED IN THE PROJECT GEOTECHNICAL REPORT AND STOCKPILED FOR REUSE AS SITE FILL. ALL DEMOLITION AND MATERIAL REUSE SHALL BE IN ACCORDANCE WITH ENVIRONMENTAL REQUIREMENTS
- SHALL BE DEEMED TO HAVE INSPECTED THE SITE AND REVIEWED ALL CONTRACT DOCUMENTS PRIOR TO SUBMITTING A BID. THE CONTRACTOR SHALL INSPECT THE SITE THOROUGHLY AND FIELD VERIFY THE LOCATION AND DEPTH OF ALL APPLICABLE EXISTING UTILITIES. SOME UNDERGROUND UTILITIES MAY BE LOCATED DIFFERENT THAN SHOWN ON THIS PLAN. ALL CONTRACTORS USING THESE PLANS FOR DEMOLITION OR CONSTRUCTION SHALL CONFIRM ALL UTILITIES IN THE FIELD TO ESTABLISH LOCATIONS, SIZES, MATERIALS, AND ELEVATIONS. ANY DISCREPANCIES SHALL IMMEDIATELY BE BROUGHT TO THE ATTENTION OF THE ENGINEER AND THE CONSTRUCTION MANAGER. CONTRACTOR SHALL PROTECT AND MAINTAIN UTILITIES
- THE CONTRACTOR SHALL CARRY OUT THE WORK OF THIS CONTRACT PLACING THE SAFETY AND PROTECTION OF THE SURROUNDING COMMUNITY AND PROPERTY AT THE HIGHEST PRIORITY. CONTRACTOR SHALL ENSURE FREE AND SAFE PASSAGE OF PERSONS AROUND THE AREA OF THE DEMOLITION AS DIRECTED BY THE GOVERNING AGENCIES AND THE OWNER. ALL OPERATIONS SHALL BE CONDUCTED SO AS TO PREVENT DAMAGE TO ADJACENT BUILDINGS, STRUCTURES, AND OTHER FACILITIES AND INJURY TO PERSONS, BOTH PEDESTRIAN AND WORKERS ALIKE. THE CONSULTANT DOES NOT HAVE THE RIGHT TO STOP DEMOLITION ACTIVITIES. SUCH DIRECTION MUST COME FROM THE

THE CONTRACTOR SHALL INSTALL AND MAINTAIN CONSTRUCTION SIGNAGE AND ASSOCIATED TRAFFIC 23.CONTRACTOR TO WASH TRUCK TIRES BEFORE EXITING MEASURES. THE CONTRACTOR SHALL FOLLOW THE WORK ZONE SAFETY GUIDELINES FOR CONSTRUCTION, MAINTENANCE AND UTILITY OPERATIONS REQUIRED BY LOCAL JURISDICTION.

- MAINTAINING THE SECURITY OF THE PROJECT SITE AT
- THE CONTRACTOR SHALL DETERMINE THE LOCATION OF ALL UTILITIES, WHETHER SHOWN OR NOT ON THE CONTRACT DRAWING, AND SHALL ABANDON, REMOVE OR PROTECT THE UTILITIES AS INDICATED HEREON OR AS DIRECTED BY THE OWNER, SUBCONSULTANT, OR INTERESTED UTILITY COMPANY.
- THE CONTRACTOR SHALL VERIFY THAT A SOIL EROSION AND SEDIMENT CONTROL PERMIT HAS BEEN OBTAINED FOR DEMOLITION ACTIVITIES. CONTRACTOR SHALL COMPLY WITH THE CONDITIONS THEREON BY INSTALLING AND MAINTAINING ALL SESC MEASURES AND MAKING THE REQUIRED NOTIFICATIONS.
- 4. THERE ARE NO WATER COURSES OR WETLANDS ON THE PROPERTY AND IT DOES NOT LIE WITHIN A REGULATED FLOOD 15. PRIOR TO DEMOLITION, THE CONTRACTOR SHALL REMOVE AND DISPOSE OF ALL CONTENTS OF THE BUILDINGS TO BE DEMOLISHED INCLUDING, BUT NOT NECESSARILY LIMITED TO, FURNISHINGS, MECHANICAL EQUIPMENT, RESERVOIR TANKS, PLUMBING FIXTURES, FURNITURE. CABINETS, ETC. IN ACCORDANCE WITH ENVIRONMENTAL REQUIREMENTS FOR THE SITE.
 - PRIOR TO DEMOLITION, THE CONTRACTOR SHALL VERIFY THAT THE UTILITY SERVICES TO BE DEMOLISHED WILL NOT AFFECT OTHER SERVICES OUTSIDE THE CONTRACT LIMIT.
 - PRIOR TO DEMOLITION, THE CONTRACTOR SHALL DISCONNECT AND CAP/TERMINATE AT THE UTILITY MAIN ALL BUILDING SÉRVICES, E.G. WATER, SEWER, GAS, ELECTRIC, TELEPHONE, ETC. (UNLESS OTHERWISE NOTED) IN ACCORDANCE WITH ALL LOCAL REGULATION AND UTILITY COMPANY REQUIREMENTS. THIS WORK SHALL INCLUDE COORDINATION WITH UTILITY COMPANIES AND OBTAINING AND PAYING FEES FOR ALL STREET AND SIDEWALK OPENING PERMITS.
 - THE CONTRACTOR SHALL DEMOLISH AND REMOVE THE BUILDINGS WHERE INDICATED, INCLUDING ALL FLOOR SLABS, PITS, WALLS, FOOTINGS, GRADE BEAMS, COLUMNS, UTILITIES ETC. ALL VOIDS REMAINING FROM THE REMOVAL OF SUBSURFACE ELEMENTS SHALL BE BACKFILLED WITH COMPACTED MATERIAL AS PER THE FINAL GEOTECHNICAL ENGINEERING REPORT.
 - ALL EXISTING SITE ELEMENTS SLATED FOR DEMOLITION SHALL BE REMOVED IN THEIR ENTIRETY INCLUDING, BUT NOT LIMITED TO, ASPHALT, BUSHES, TREES, PLANTERS, ETC. WITHIN THE CONTRACT LIMITS UNLESS OTHERWISE NOTED.
 - CONTRACTOR TO VERIFY THAT ALL ENVIRONMENTAL CONCERNS (ASBESTOS, LEAD BASED PAINT, HAZMAT MATERIALS, UNDERGROUND STORAGE TANKS, TRANSFORMERS, ETC.) HAVE BEEN REMOVED PRIOR TO COMMENCEMENT OF DEMOLITION ACTIVITIES. THESE POTENTIAL CONCERNS ARE NOT SHOWN ON THIS PLAN. THE CONTRACTOR SHALL REFER TO THE ENVIRONMENTAL REPORTS AND DOCUMENTS FOR ENVIRONMENTAL CONCERN LOCATIONS AND DISPOSAL PROCEDURES.
 - ^{O.}CONTRACTOR IS RESPONSIBLE FOR KEEPING ALL ADJACENT RIGHT-OF-WAYS AND ADJACENT PROPERTIES CLEAN DURING DEMOLITION.
 - CONTRACTOR SHALL STOCKPILE REMOVED ASPHALT AND CONCRETE IN SEPARATE PILES. REMOVED MATERIAL MAY BE REUSED IN ACCORDANCE WITH THE GEOTECHNICAL REPORT AND ENVIRONMENTAL REQUIREMENTS.
 - 2.CONTRACTOR TO PROVIDE DUST CONTROL MEASURES DURING DEMOLITION AND CONSTRUCTION ACTIVITIES.

THE CONSTRUCTION SITE.

- 4-EXISTING IRRIGATION WELLS ONSITE SHALL BE DECOMMISSIONED BY NJ LICENSED WELL DRILLER.
- ²⁵PER CITY ORDINANCE ALL UTILITY SERVICES TO BE ABANDONED ARE TO BE DISCONNECTED AT THE MAIN AND REMOVED FROM THE GROUND.



CASAS DEL RIO

CITY OF CAMDEN, NJ

CAMDEN LUTHERAN HOUSING INC.

137 Lake Road Valley Cottage, NY 10989

35 Gates Avenue, Warren, NJ 07059 Tel: (908) 698-2890 Fax: (908) 926-2359 NJ Certificate of Authorization for Engineering 24GA28135000



	DATE	ISSUE	DESCRIPTION	
	6/28/2024	1	PLANNING BD. SUBMISSION	
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CASAS DEL RIO CAMDEN LUTHERAN HOUSING INC. NORTH CAMDEN, NJ

Drawing Title

SITE DEMOLITION PLAN

Drawing No.


C-100

MICHAEL I. MILLA

23-014

AS NOTED

rawn/Checked by CAJ/CJ NJ LIC. No. 22414

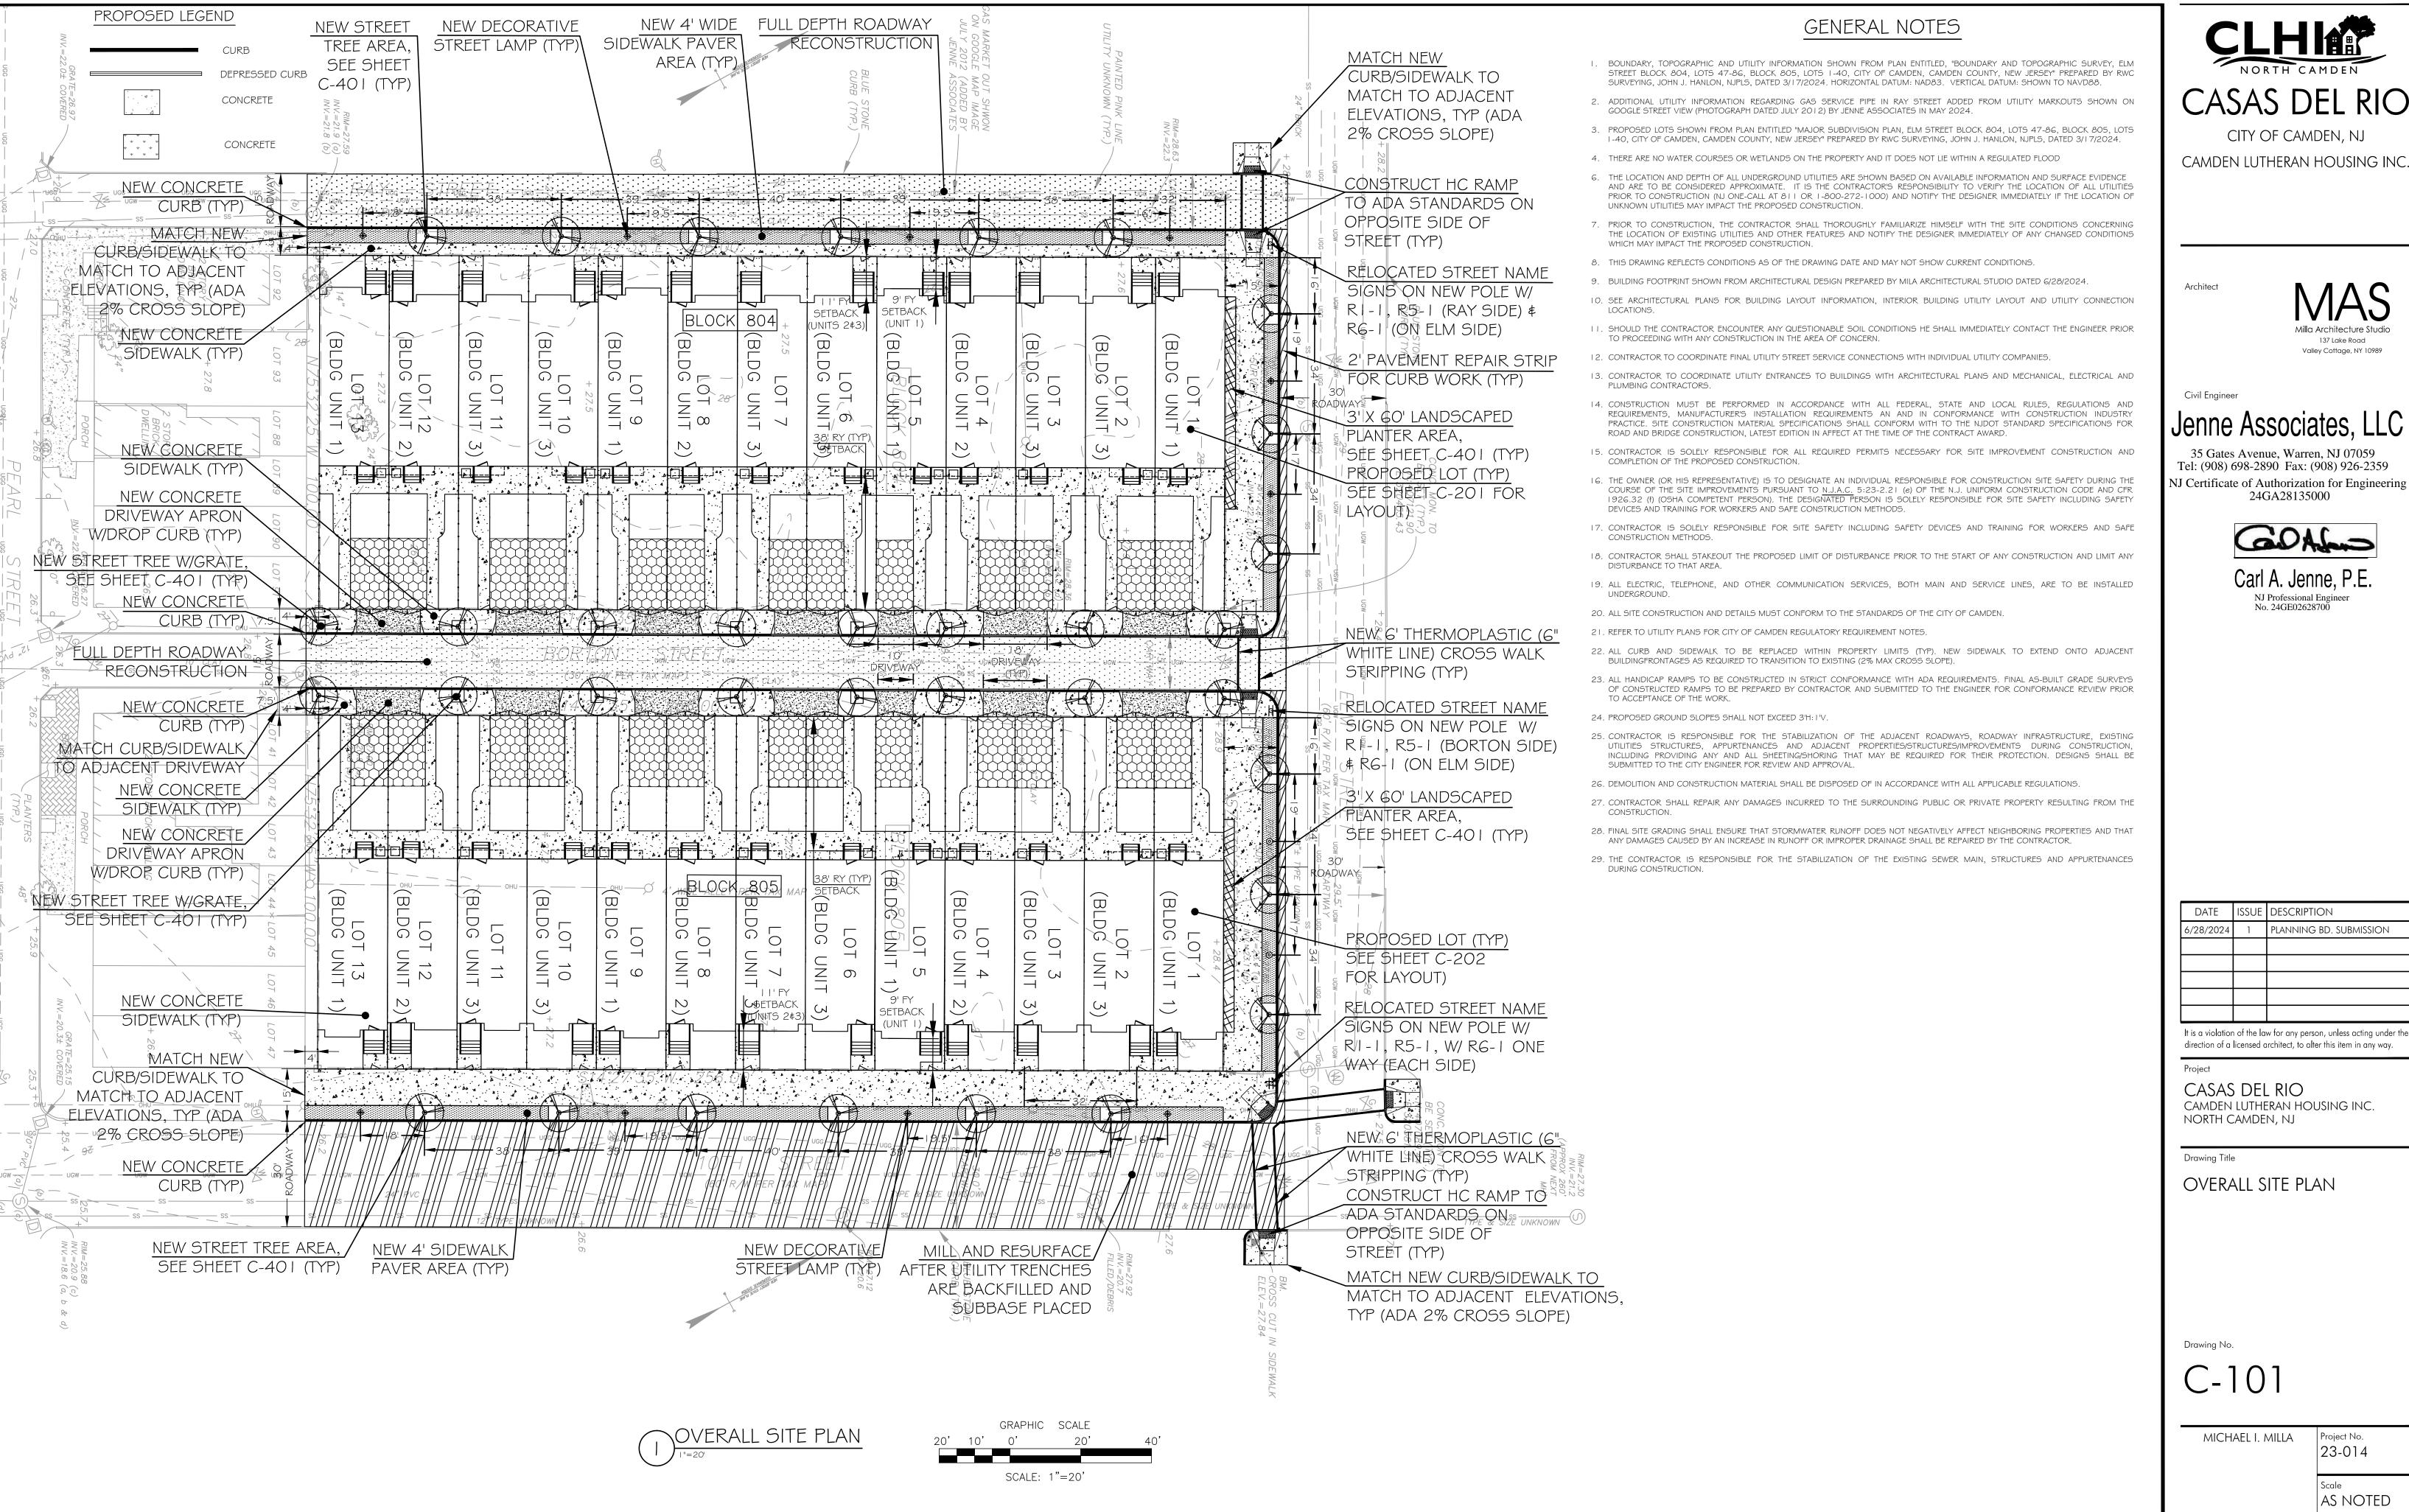

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CITY OF CAMDEN, NJ

137 Lake Road Valley Cottage, NY 10989

Civil Engineer

Jenne Associates, LLC

35 Gates Avenue, Warren, NJ 07059 Tel: (908) 698-2890 Fax: (908) 926-2359 NJ Certificate of Authorization for Engineering 24GA28135000



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CASAS DEL RIO CAMDEN LUTHERAN HOUSING INC. NORTH CAMDEN, NJ

Drawing Title

OVERALL SITE PLAN

Drawing No.

C-101

MICHAEL I. MILLA

23-014

AS NOTED

Drawn/Checked by CAJ/CJ

CAMDEN CITY ORDINANCE SPECIFICATIONS PER CITY SIDEWALK APPLICATION NOTES:

- .. CONCRETE MUST BE PORTLAND CEMENT CONCRETE, AIR-ENTRAINED, CONFORM TO THE NJDOT STANDARD SPECIFICATIONS FOR CLASS B CONCRETE, AND MUST HAVE A MINIMUM COMPRESSIVE STRENGTH OF 4,500
- B. INSTALL EXPANSION JOINT PAPER AGAINST EXISTING CONCRETE AND EVERY 20 FT.
- GRADES AND CROSS SLOPES: THE MAXIMUM SIDEWALK CROSS SLOPE IS 2%. THE MAXIMUM GRADE IS 12:1 (8.33%), HOWEVER, THE LONGITUDINAL GRADE OF THE SIDEWALK SHOULD BE CONSISTENT WITH THE GRADE OF THE ADJACENT ROADWAY. IF THE 12:1 GRADE IS NOT FEASIBLE DUE TO TOPOGRAPHY AND OTHER PHYSICAL CONSTRAINTS, THEN THE GRADE SHOULD BE DEVELOPED TO THE EXTENT FEASIBLE. WHEN SIDEWALK GRADES ARE STEEPER THAN 12:1 FOR A MAXIMUM DISTANCE OF 30 FEET ARE UNAVOIDABLE, A LEVEL 4 FOOT LONG LANDING SHOULD BE INCLUDED IF FEASIBLE (OR AT A DISTANCE THAT IS PRACTICABLE). SIDEWALK DEPTH: 5 IN. NOTE NOT EXCEED 2%, APRON DEPTH: 6 IN. NOT TO EXCEED 8%, HANDICAP RAMP DEPTH 6 IN., HANDICAP RAMPS SHALL BE INSTALLED UNDER ADA GUIDELINES. PLEASE REFER TO A LICENSED SURVEYOR AS NEEDED.
- TWO INSPECTIONS WILL BE PERFORMED PRIOR OF APPROVING WORK: 1) FORM INSPECTION, 2) POUR INSPECTION.
- CONTRACTOR OR UTILITY CO. RESPONSIBLE TO SUPPLY A CONCRETE SLIP.
- CURB INSTALLATION: MATCH EXISTING (PROVIDING AREAS ARE SMALL). PLEASE CONTACT INSPECTOR CARDI TO VERIFY APPROVED ADJUSTMENTS.
- G. CURB INSTALLATION: CURB DIMENSION 18 IN. VERTICAL, 7" WIDE (TOP), 8" WIDE (BOTTOM) (LARGE AREAS).
- H. CONTRACTOR OR UTILITY CO. MUST USE WATER WHEN SAW CUTTING CONCRETE OR ASPHALT TO PREVENT DUST IN THE AIR. CONTRACTOR/UTILITY CO. RESPONSIBLE TO CALL IN FOR MARKOUTS "811". STREET RESTORATION: EXISTING CONCRETE BASE AND ASPHALT TOP: INSTALL 6 IN. CONCRETE BASE AND
- NJDOT ASPHALT TOP 2 IN. NOTE: EXISTING ASPHALT MUST BE SAW CUTTED SQUARE AT LEAST FOUR IN. BACK FROM EXISTING OPENING AROUND PERIMETER.
- STREET RESTORATION: ASPHALT STREET: NJDOT ASPHALT BASE, 6 IN., 2 IN. ASPHALT TOP, HOT TACK SEAMS INNER AND OUTER SEAM. COLD TACK IS NOT ACCEPTED.
- . STREET RESTORATION: CONCRETE STREET: 8 IN. DEPTH (CITY)

HOT MIX ASPHALT (HMA) CONCRETE SURFACE COURSE (9.5M64)

HOT MIX ASPHALT (HMA) CONCRETE SE/ BINDER COURSE (25M64/19M64)* DENSE GRADE AGGREGATE (DGA)

COMPACTED FIRM SUBGRADE

DETAIL)

SUBMITTAL TO THE OWNER'S ENGINEER FOR REVIEW AND APPROVAL

- WAITING TIME FOR CONCRETE SETTING UP IN THE STREET, WAITING PERIOD SHOULD BE A MINIMUM OF THREE DAYS PRIOR OF INSTALLING ASPHALT. STEEL PLATES SHOULD BE IN PLACE FOR THE SAFETY OF THE RESIDENTS OF THE CITY OF CAMDEN.
- M. ROAD RESTORATION: CONCRETE ROAD; 9 TO 10 IN. DEPTH AND INSTALL DOWEL RODS IN EXISTING SLAB. UTILITY CO. OR CONTRACTOR MUST REMOVE WHOLE SLAB (JOINT TO JOINT).
- N. PLEASE PROVIDE 95% TO 98% COMPACTION, COMPACT IN 12 IN. LIFTS, CONTRACTOR OR UTILITY CO. MUST USE NJDOT CERTIFIED CLEAN FILL (DGA).
- O. INSPECTION SCHEDULING: PLEASE CALL MRS. WALKER AT (856) 757-7680
- CONTRACTOR OR UTILITY CO. RESPONSIBLE TO CLEAN AREA AND SECURE ALL EQUIPMENT PRIOR OF DEPARTING WORK AREA. CITY OF CAMDEN ACCEPTS NO LIABILITY.
- . CONTRACTOR/UTILITY CO. RESPONSIBLE TO PROVIDE TEMPORARY TRAFFIC CONTROL PLAN IN COMPLIANCE WITH MUTCD REQUIREMENTS IF NEEDED. REFER TO CAMDEN COUNTY POLICE DEPT. TRAFFIC CONTROL OFFICER LT. MOFFA AT (856) 757-7280. NOTE: MUST BE PRE-APPROVED PRIOR OF WORKING IN THE STREET OR SIDEWALK (IF RESTRICTING TRAFFIC). NOTE: SIDEWALK CLOSED: PLEASE INSTALL PEDESTRIAN SIDEWALK CLOSED SIGNS WITH ARROW DIRECTING ACROSS THE STREET OR PROVIDE OTHER OPTIONS IN COMPLIANCE

1.5 INCHES 2.5 INCHES 4 INCHES
1.5 INCHES 4 INCHES 6 INCHES

ASPHALT SECTION SURFACE COURSE - 'X' BASE COURSE - 'Y' SUBBASE - 'Z'

PUBLIC RIGHT-OF-WAY 2 INCHES 4 INCHES 6 INCHES

NOTE: THICKNESSES TO BE CONFIRMED BY GEOTECHNICAL ENGINEER OF RECORD

* BITUMINOUS CONCRETE BASE COURSE (25M64) TO BE USED FOR HEAVY DUTY. ALL

PRIOR TO ANY ASPHALT PAVING ACTIVITIES, THE PAVEMENT SUBGRADE AND SUBBASE SHALL BE PROPERLY PREPARED AND ADEQUATELY COMPACTED AS REQUIRED BY GEOTECHNICAL ENGINEER OF RECORD

ALL AREAS TO BE PAVED SHALL BE PROOFROLLED WITH A SMOOTH ROLLER HAVING A MINIMUM STATIC

DRUM WEIGHT OF 5-TONS AND A FULLY LOADED TRI-AXLE DUMP TRUCK. ANY SOFT AREAS SHALL BE REMOVED AND REPLACED WITH APPROVED, COMPACTED FILL. FILL SHALL BE PLACED IN LOOSE LIFTS NOT

REMOVED AND REPLACED WITH APPROVED, COMPACTED FILL. FILL SHALL BE PLACED IN LOOSE LIFTS NOT TO EXCEED 12—INCHES AND SHALL BE COMPACTED TO AT LEAST 95% OF ITS MAXIMUM DRY DENSITY AS DETERMINED BY ASTM D-1557.

THE ASPHALT MIXTURE, AFTER BEING SPREAD, SHALL BE THOROUGHLY COMPACTED BY ROLLING AS SOON AS IT WILL BEAR THE WEIGHT OF THE ROLLERS WITHOUT UNDUE DISPLACEMENT. THE NUMBER, WEIGHT, AND TYPES OF ROLLERS AND SEQUENCES OF ROLLING OPERATIONS SHALL BE SUCH THAT THE REQUIRED DENSITY AND SURFACE ARE CONSISTENTLY ATTAINED WHILE THE MIXTURE IS IN A WORKABLE CONDITION.

ASPHALT SHALL BE COMPACTED TO A MINIMUM OF 93% OF THE MAXIMUM THEORETICAL DENSITY ACCORDING

TO ASTM D2041 FOR THE 9.5M64 AND 19M64 COURSES. FOR THE 25M64 COURSE, THE ASPHALT SHALL BE COMPACTED TO A MINIMUM OF 92% OF THE MAXIMUM THEORETICAL DENSITY, OR IN ACCORDANCE WITH

GEOTECHNICAL ENGINEER OF RECORD RECOMMENDATION.


A TESTING AGENCY SHALL PERFORM IN PLACE DENSITY TESTS AS PART OF THE CONSTRUCTION TESTING REQUIREMENTS USING THE NUCLEAR METHOD IN ACCORDANCE WITH ASTM D-2922 METHOD B DIRECT

APPLY TACK COAT TO ASPHALTIC CONCRETE BASE COURSE PRIOR TO PLACING SURFACE COURSE. APPLY EMULSIFIED ASPHALT TACK COAT BETWEEN EACH LIFT OR LAYER OF FULL DEPTH ASPHALTIC CONCRETE BASES, WHERE APPLICABLE.


ASPHALT PAVING OPERATIONS SHALL ONLY OCCUR WHEN ATMOSPHERIC TEMPERATURE IS ABOVE 40T. DO

NOT PLACE ASPHALT ON FROZEN GROUND OR IN STANDING WATER. DO NOT PAVE IN THE RAIN.

OTHER PAVEMENT AREAS TO USE BITUMINOUS CONCRETE BINDER COURSE (19M64).

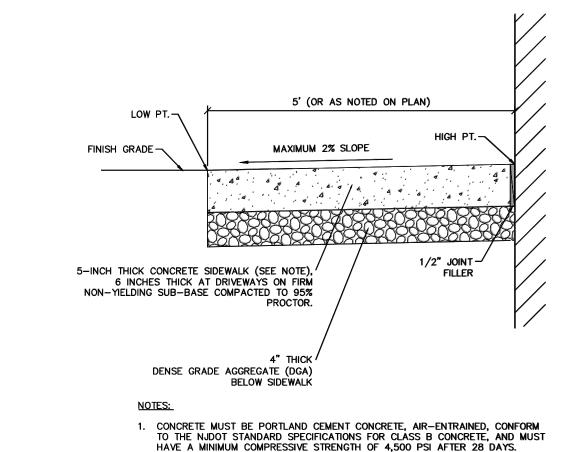

CAMDEN CONCRETE SIDEWALK DETAIL

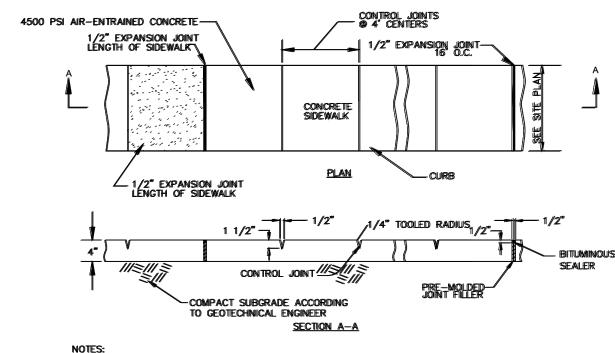

- ALL SIDEWALKS SHALL BE FLOATED, TOOLED, AND SOFT BROOM BRUSHED. SIDEWALKS SHALL BE INSTALLED ON AN APPROVED, COMPACTED SUBGRADE.
- MAXIMUM CROSS SLOPE OF 1/4" PER FOOT.

ONSITE CONCRETE SIDEWALK DETAIL


GALVANIZED STEEL U -FINISHED -GRADE FOOTING - NJDOT CONCRETE, 4000 PSI. AIR ENTRAINED

- ALL POSTS SHALL BE OF ADEQUATE LENGTH TO MEET THE REQUIREMENTS FOR ERECTION AS STATED IN THE CURRENT "MANUAL OF UNIFORM TRAFFIC CONTROL DEVICES FOR STREETS AND HIGHWAYS".
- 2. ALL POSTS AND BRACKETS SHALL BE CUT AND BENT AND THE HOLES SHALL BE PUNCHED OR DRILLED BEFORE GAVANIZING. GALVANIZING SHALL CONFORM TO THE CURRENT A.S.T.M. SPECIFICATIONS.







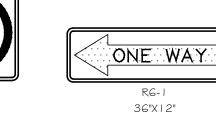





12"x18"




CURB AT GUTTER LINE TO BE

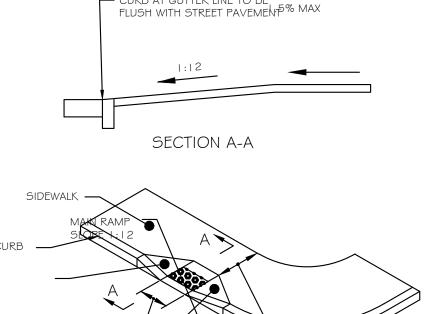


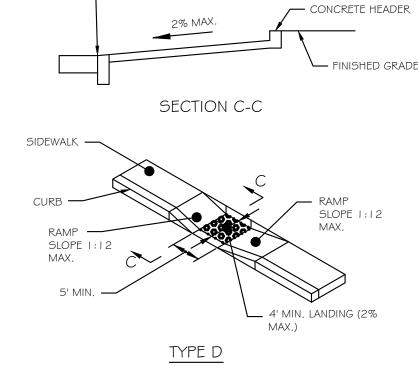


CURB AT GUTTER LINE TO BE


FLUSH WITH STREET PAVEMENT

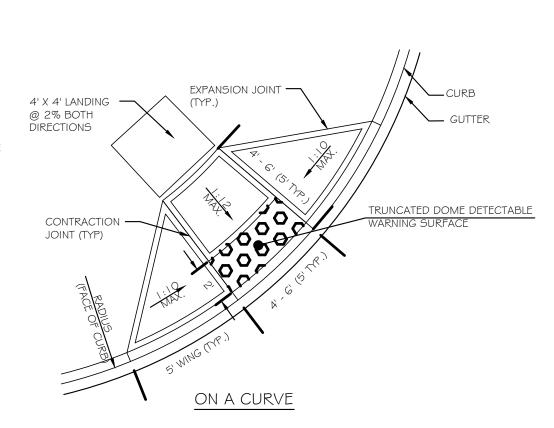

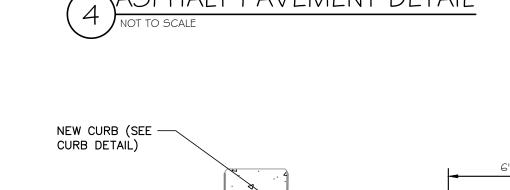

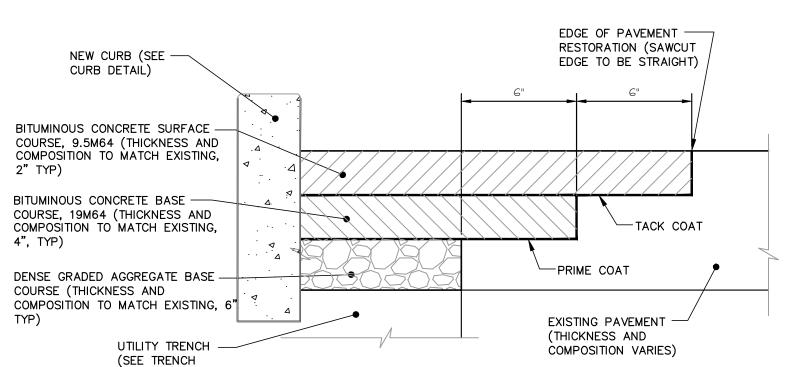

ROADWAY PAVEMENT RESTORATION DETAIL

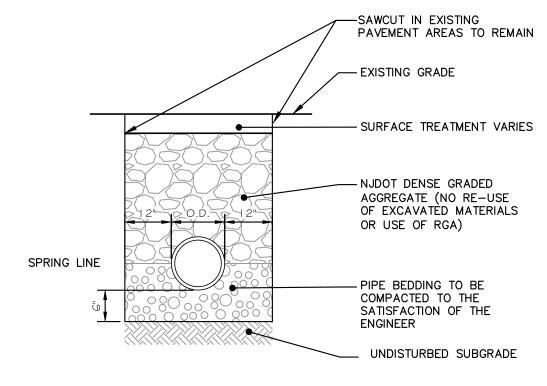

WIDTH OF CURB CUT

TRUNCATED DOME (T.D.) —

NOTES:

1' TO 2'

 $\circ \circ \circ \circ \circ \circ$

0 0 0 0 0

0 0 0 0 0

0 0 0 0 0

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1.6" MIN. TO 2.4" MAX. CENTER TO CENTER T.D. SPACING

ELEVATION

DETECTABLE WARNING SURFACE (DWS) SHALL EXTEND FULL WIDTH OF CURB RAMP (EXCLUSIVE OF FLARES) OR FULL WIDTH OF LANDING/TURNING SPACE.
 DWS SHALL EXTEND 2 FEET MINIMUM IN THE DIRECTION OF PEDESTRIAN TRAVEL.
 TYPICALLY, DWS SHALL BE PLACED ADJACENT TO BACK OF CURB.

EXISTING PAVEMENT SURFACE

WHERE NO ELEVATION ARE GIVEN ON

THE PLAN, MATCH THE PROJECTED TOP OF EXISTING CURB. THE

PROJECTED TOP OF CURB SHALL BE DETERMINED BY A STRING LINE.

TO TO THE TICAL CONCRETE CURB DETAIL

1. WHEN NEW CURB IS CONSTRUCTED ALONG AN EXISTING PAVED AREA, THE EXISTING PAVEMENT SHALL BE CUT IN A STRAIGHT LINE PARALLEL TO FACE OF NEW CURB WITH A SHARP TOOL AND THE NEW PAVEMENT SHALL BE TACKED

2. EXPANSION JOINTS 1/2" WIDE SHALL BE INSTALLED IN THE CURB 20' APART AND FILLED WITH CELLULAR COMPRESSION MATERIAL AS SPECIFIED AND RECESSED 1/4" FROM FACE AND TOP OF CURB. EXPANSION JOINTS TO BE

NCLUDED IN PRICE BID FOR CURB. CONSTRUCTION JOINT SHALL BE MID-POINT

3. CONCRETE MUST BE PORTLAND CEMENT CONCRETE, AIR—ENTRAINED, CONFORM TO THE NJDOT STANDARD SPECIFICATIONS FOR CLASS B CONCRETE, AND MUST HAVE A MINIMUM COMPRESSIVE STRENGTH OF 4,500 PSI AFTER 28 DAYS.

AND BUTTED TO EXISTING PAVEMENT.

DETECTIBLE WARNING SURFACE DETAIL

T.D. ALIGNED WITH DIRECTION

- 0.45" MIN. TO 0.90" MAX. TOP

— 0.90" MIN. TO 1.4" MAX. BASE

OF PEDESTRIAN TRAVEL

- I. SURFACE JOINT SHALL BE SEALED WITH EMULSIFIED ASPHALT RS-I OR APPROVED EQUAL. NO SEPERATE PAYMENT WILL BE MADE.
- 2. BACKFILL SHALL BE COMPACTED IN 6" LIFTS WITH A FLAT FACE MECHANICAL TAMPER TO THE SATISFACTION OF THE ENGINEER.

TRENCHING DETAIL

SIDF RAMP

SLOPE 1:10

- I. RAMPS AND SIDE RAMPS SHALL HAVE A HAND BROOMED FINAL FINISH.
- 2. SEE PLANS FOR EXACT LOCATION OF RAMPS.

TYPE A


- 3. ALL RAMPS SHALL BE PROVIDED WITH DETECTABLE WARNINGS CONSISTING OF RAISED OR TRUNCATED DOMES (DIA. 0.9 IN., HEIGHT 0.2 IN., CENTER TO CENTER SPACING 2.35 IN.) VISIBLITY SHALL CONTRAST WITH THE WALKING SURFACE.
- 4. DETECTABLE WARNINGS SHALL EXTEND THE FULL WIDTH AND DEPTH OF THE RAMP, INCLUDING SIDE FLARES.

- 4' MIN. LANDING AREA

CROSS SLOPE 1.5% MAX.

5. DETECTABLE WARNINGS MAY BE WORKED INTO THE CONCRETE (TRUNCATED) OR BE A FABRICATED SHEET THAT IS ATTACHED TO THE SURFACE. ALL FABRICATED PIECES SHALL BE APPROVED BY THE ENGINEER PRIOR TO FABRICATION



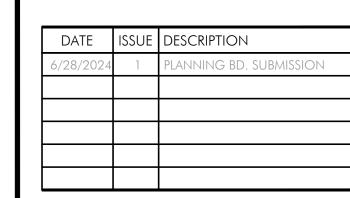

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CASAS DEL RIO CAMDEN LUTHERAN HOUSING INC. NORTH CAMDEN, NJ

Drawing Title

SITE DETAILS


Drawing No.

MICHAEL I. MILLA Project No. 23-014

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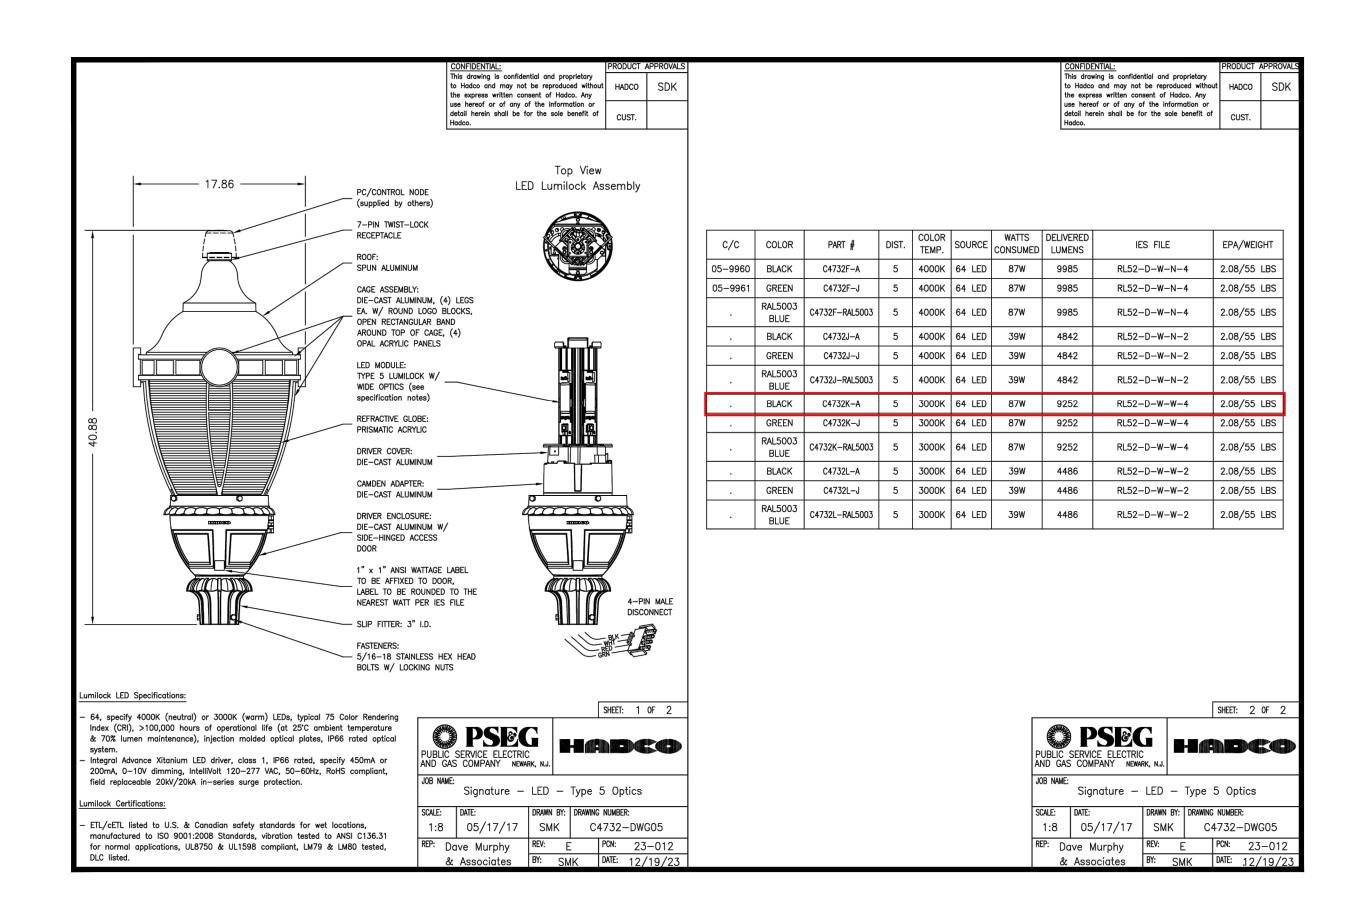
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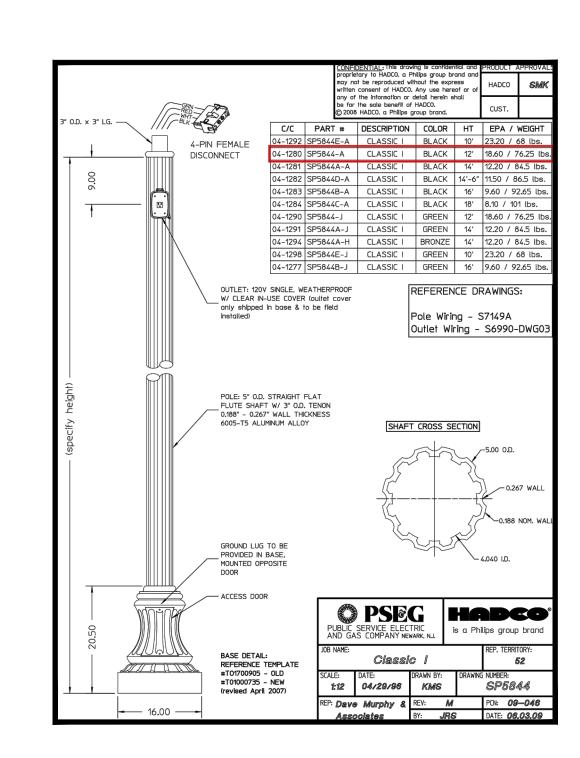






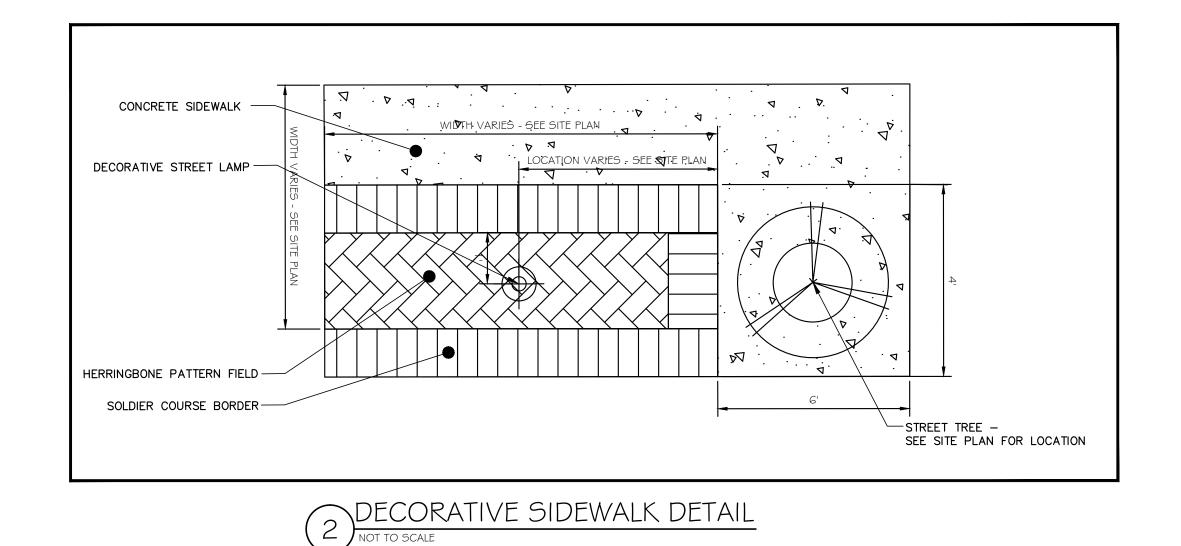





DECORATIVE STREET LAMP POLE DETAIL



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CAMDEN LUTHERAN HOUSING INC.
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Drawing Title

SITE DETAILS 2

Drawing No.

C-103

MICHAEL I. MILLA


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Drawing Title

BLOCK #804 DETAILED SITE AND GRADING PLAN


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Drawing Title

BLOCK #805 DETAILED SITE AND GRADING PLAN

Drawing No.

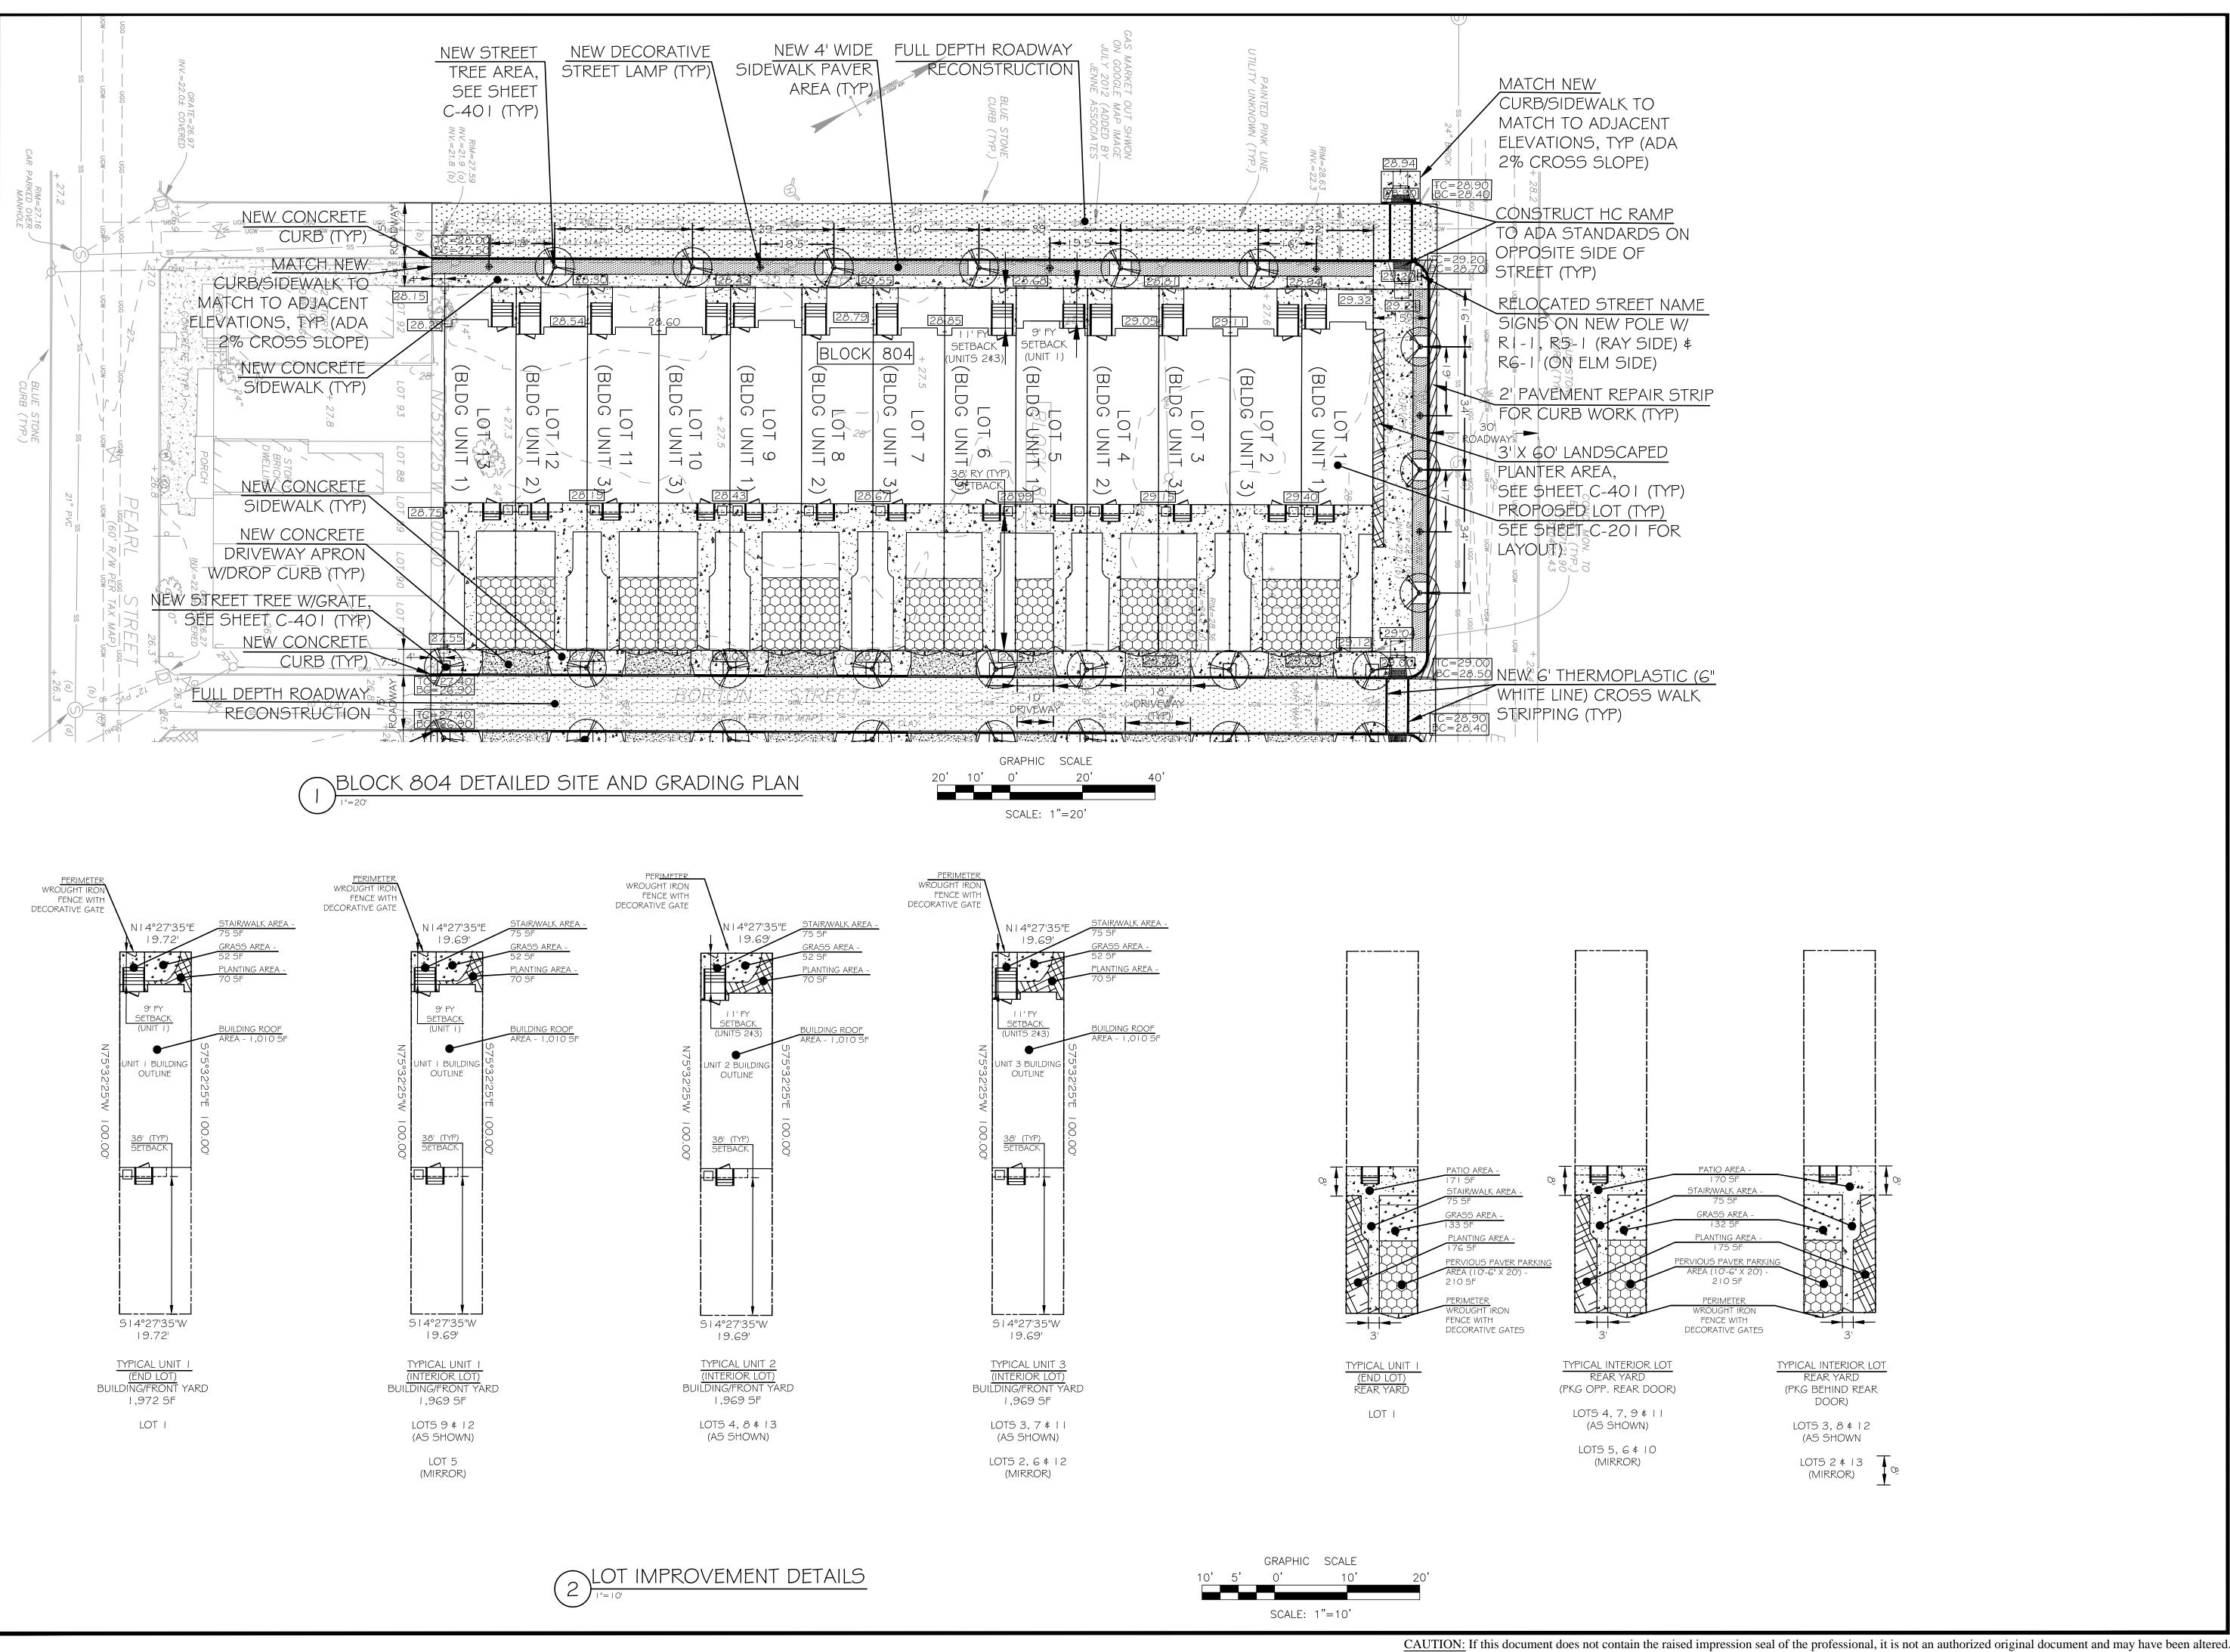
C-202


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SANITARY SEWER FLOW

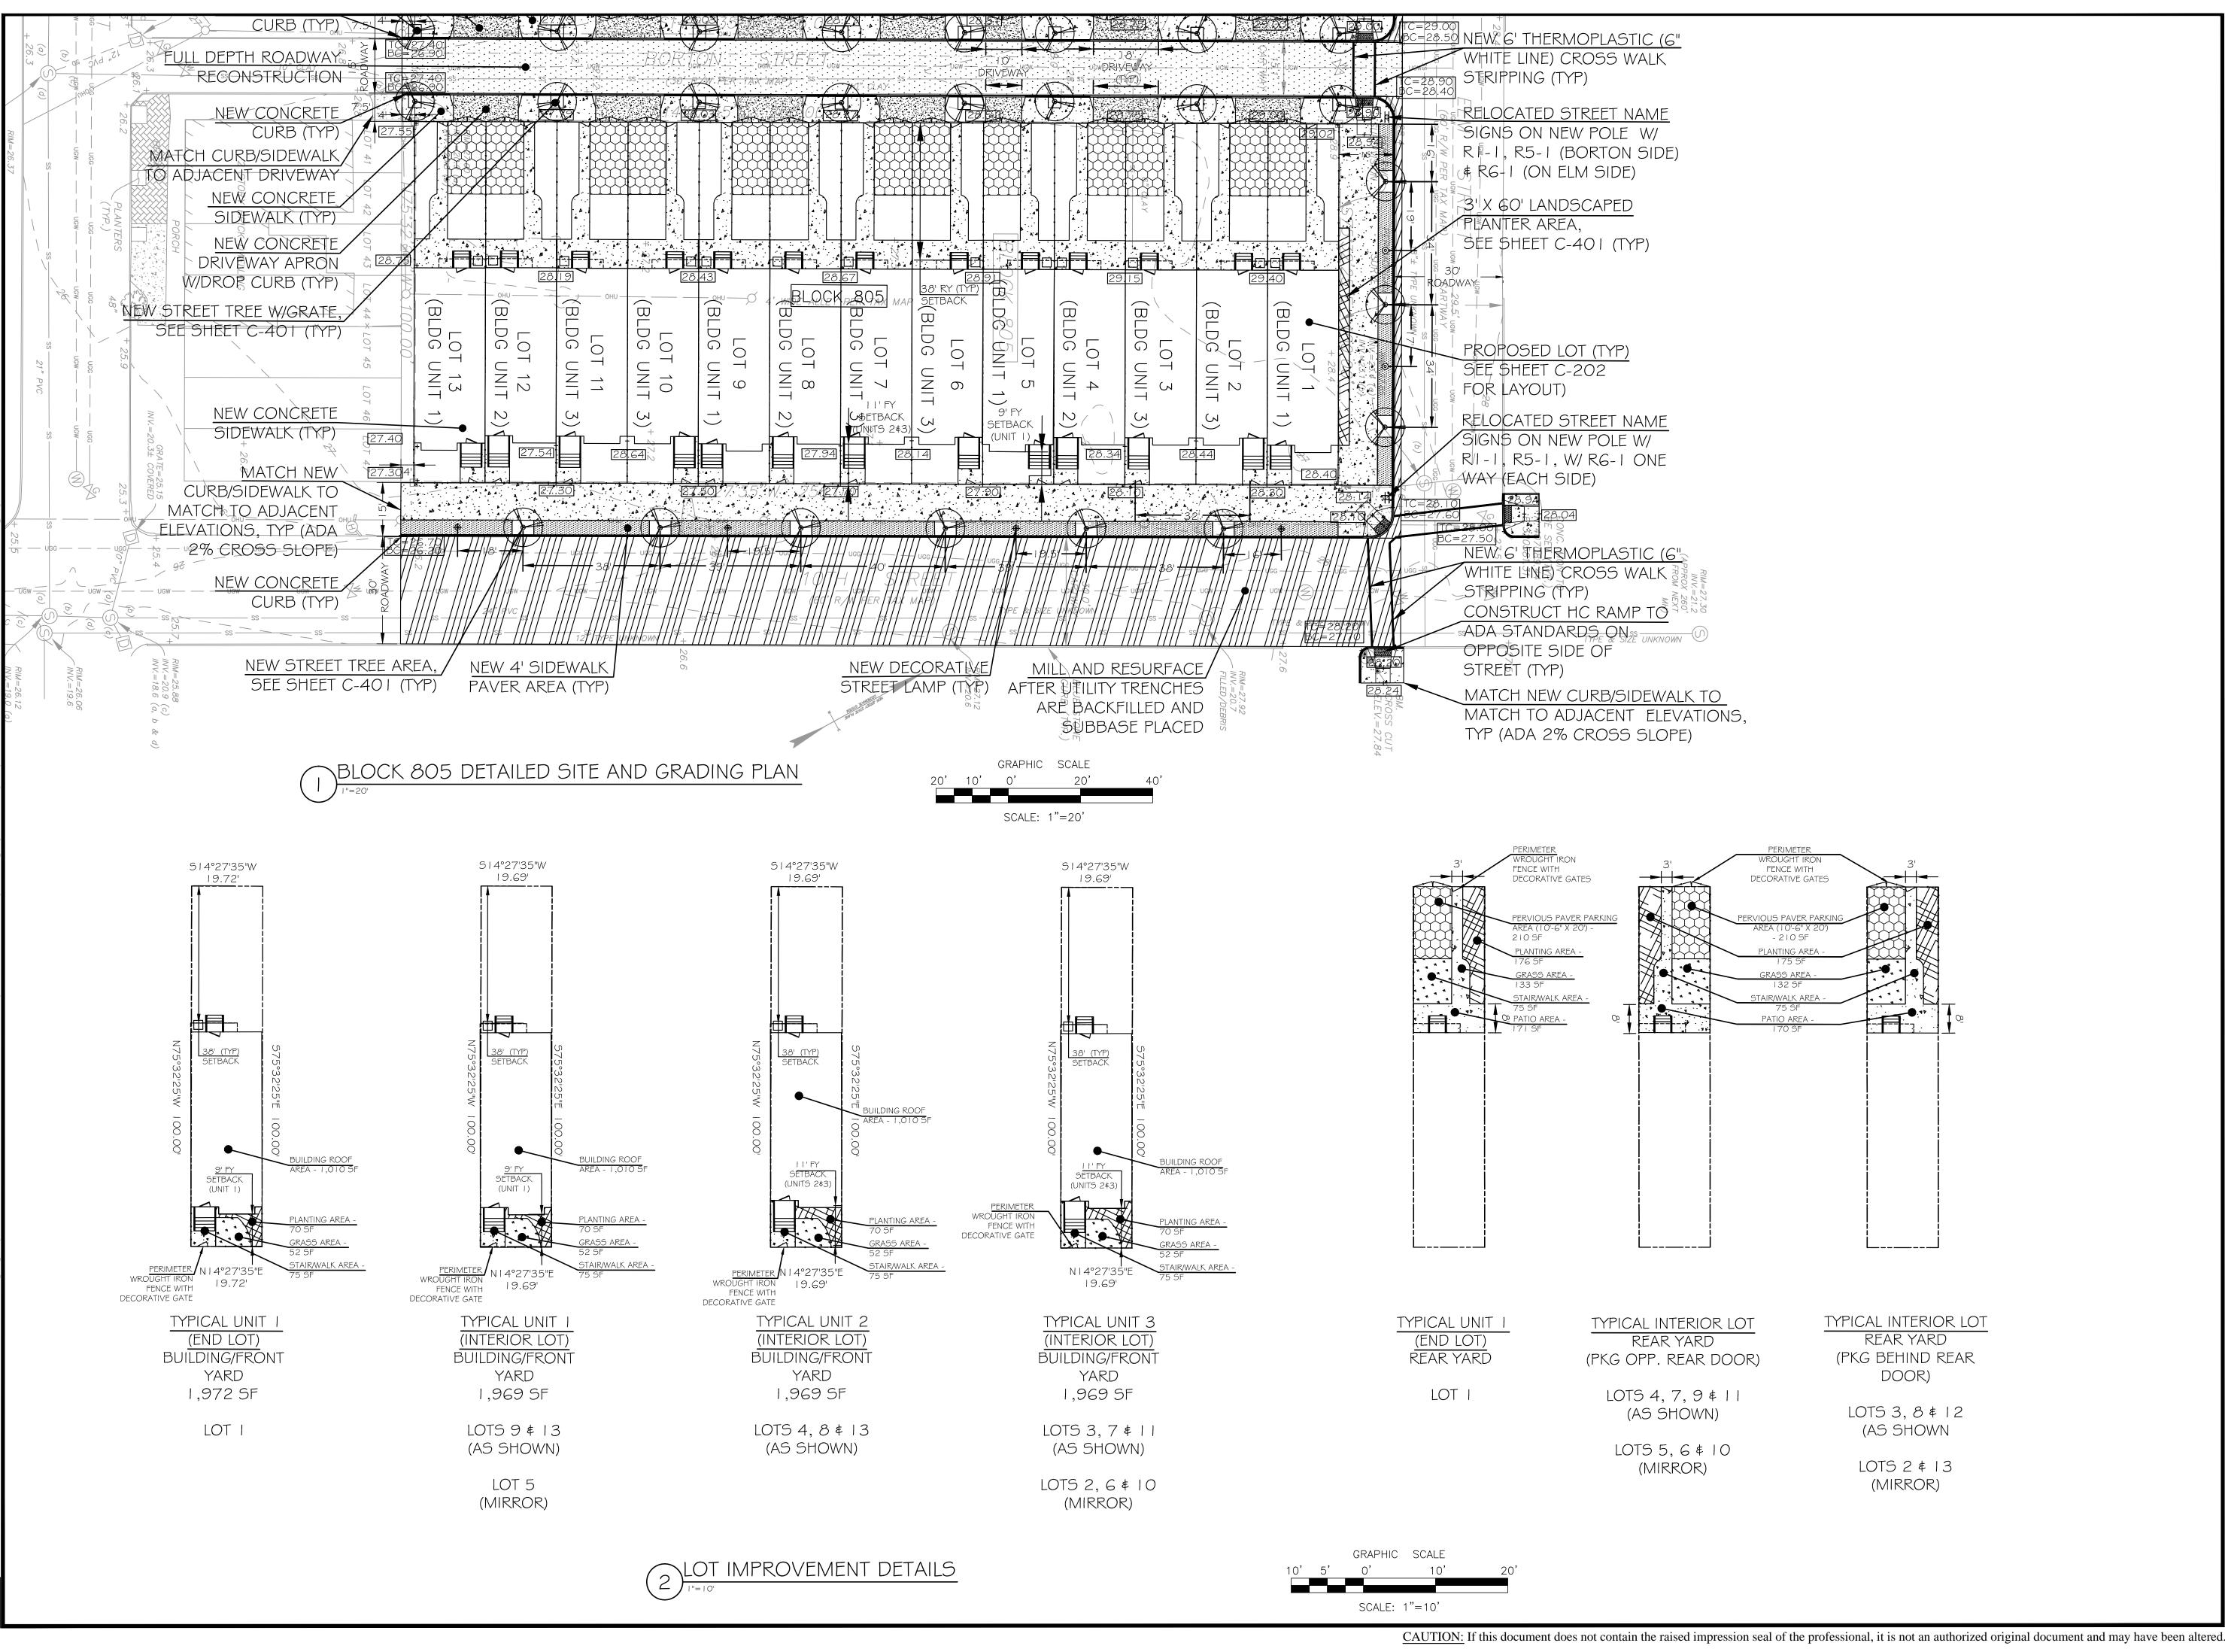SANITARY SEWER FLOW CALCULATION

3 BEDROOM HOUSE @ 300 GPD

BLOCK 804: 13 HOUSES @ 300 GPD = 3,900 GPD

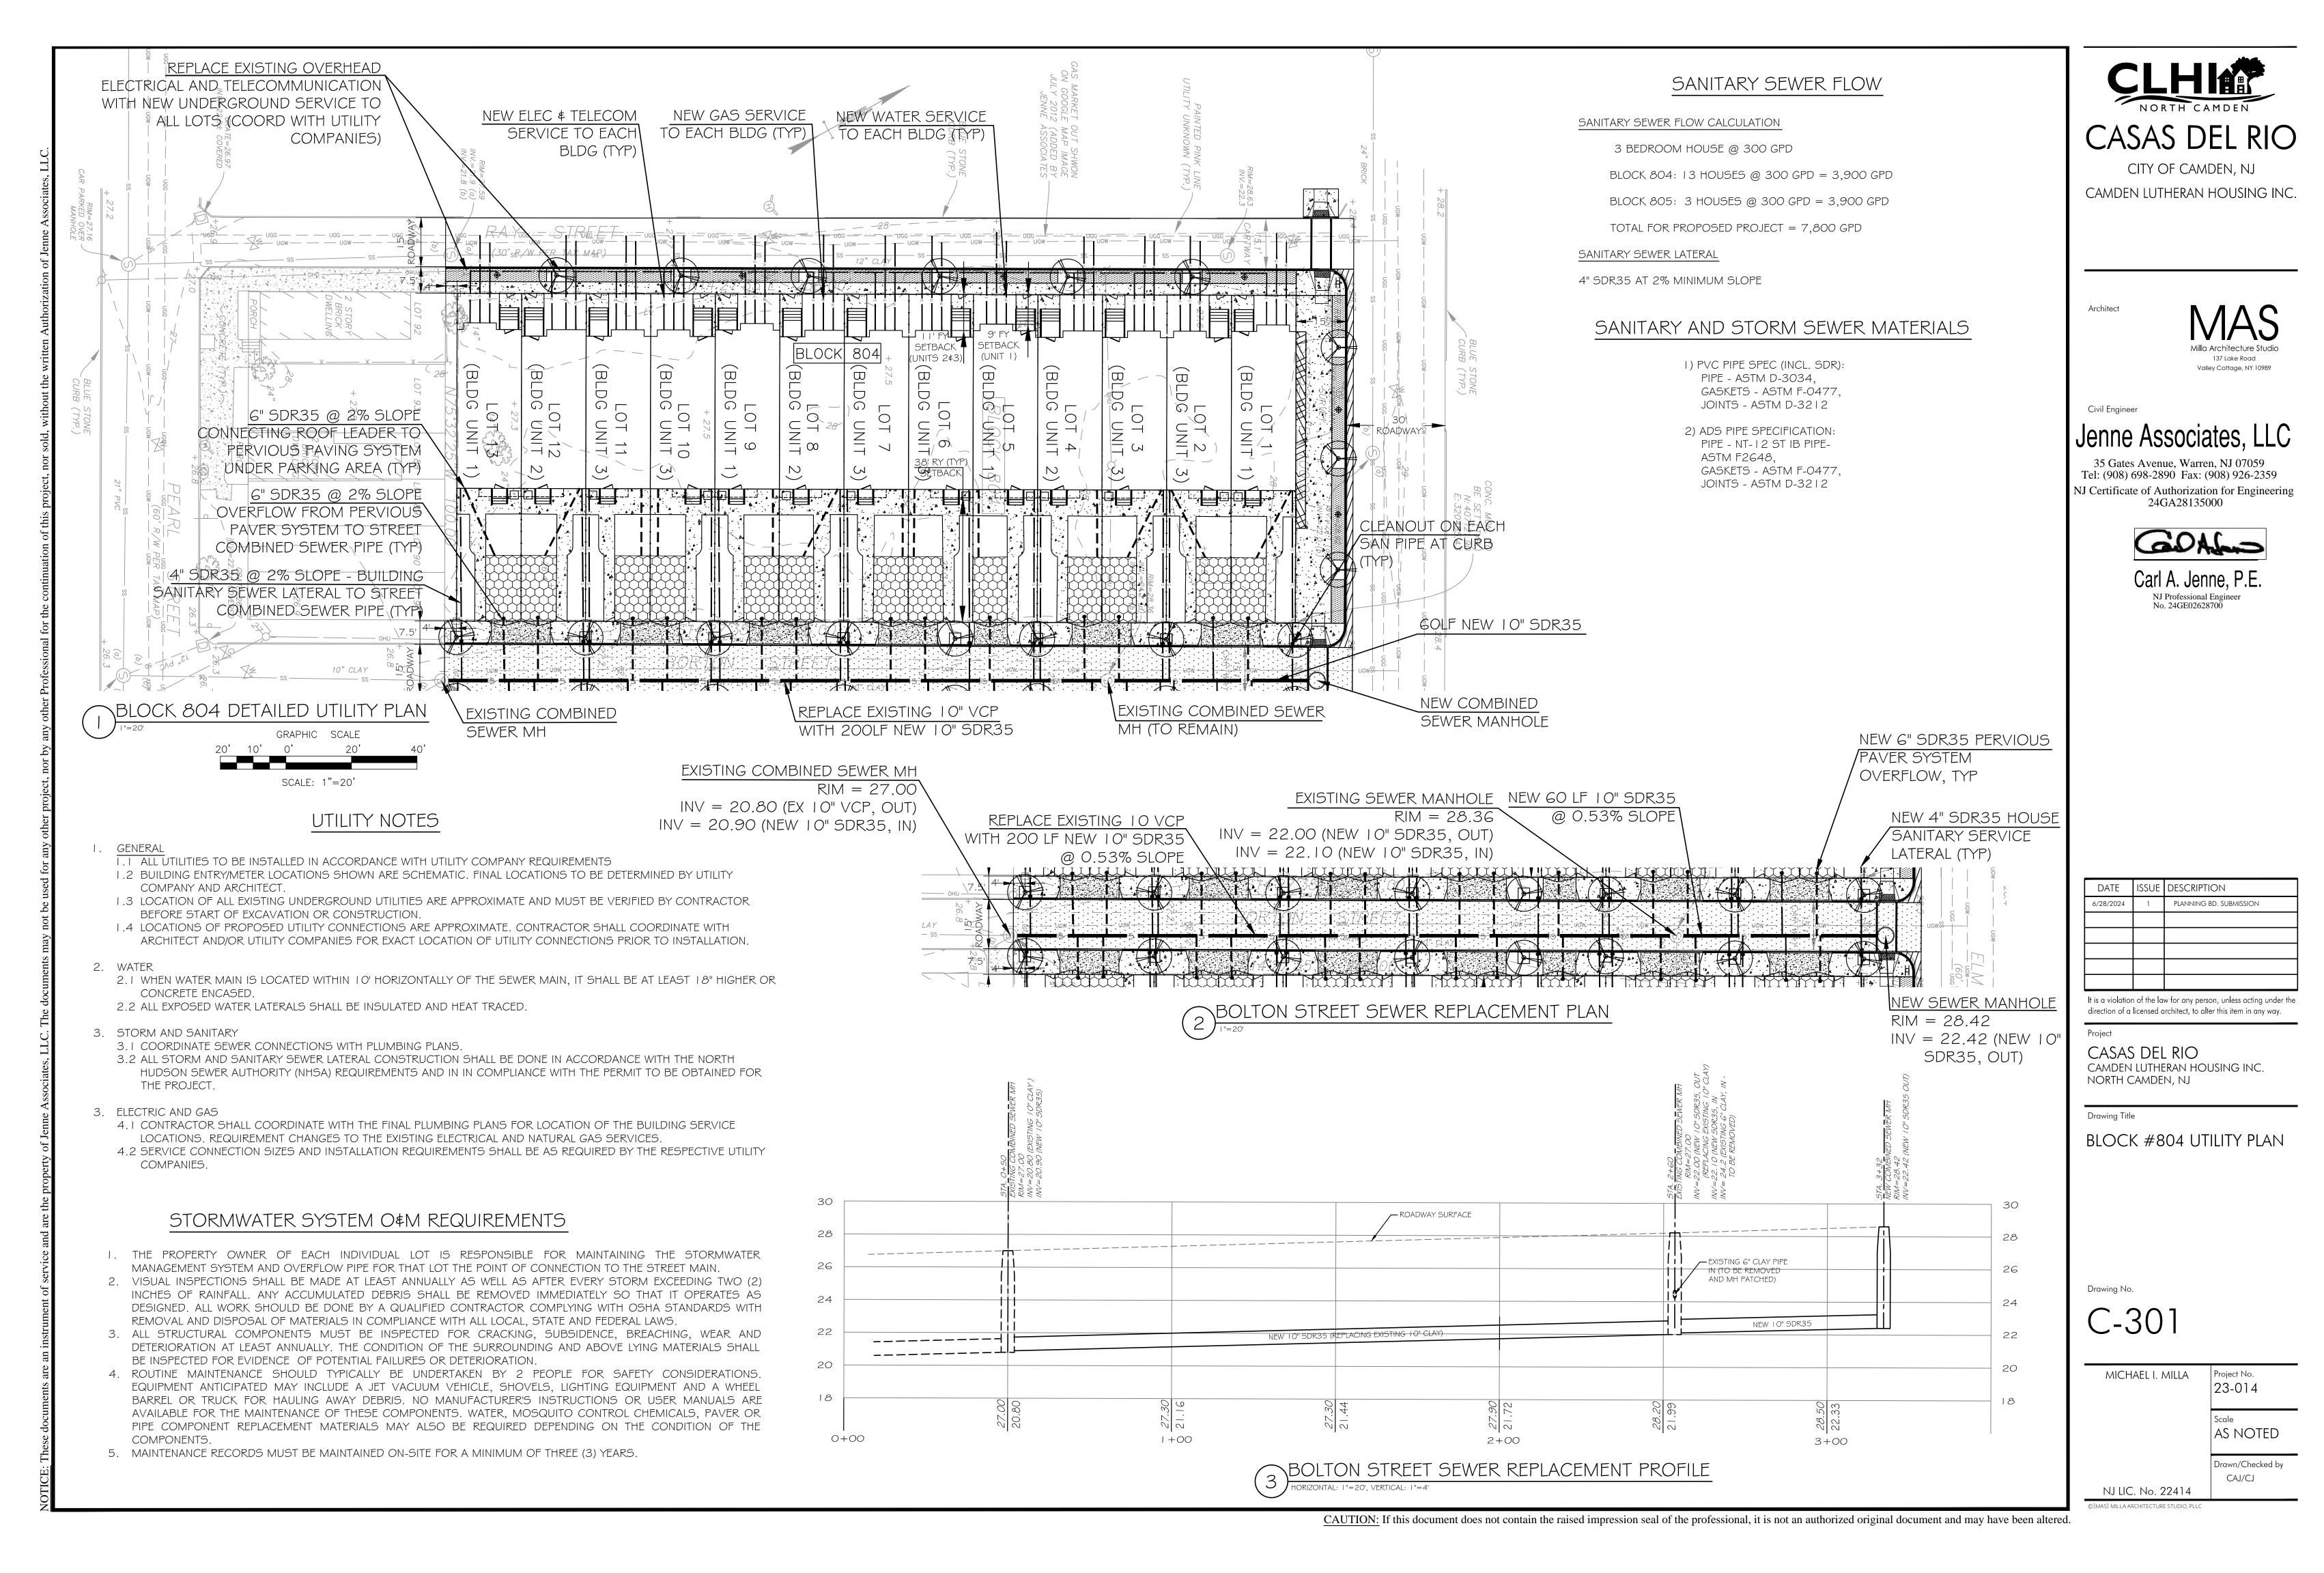BLOCK 805: 3 HOUSES @ 300 GPD = 3,900 GPD

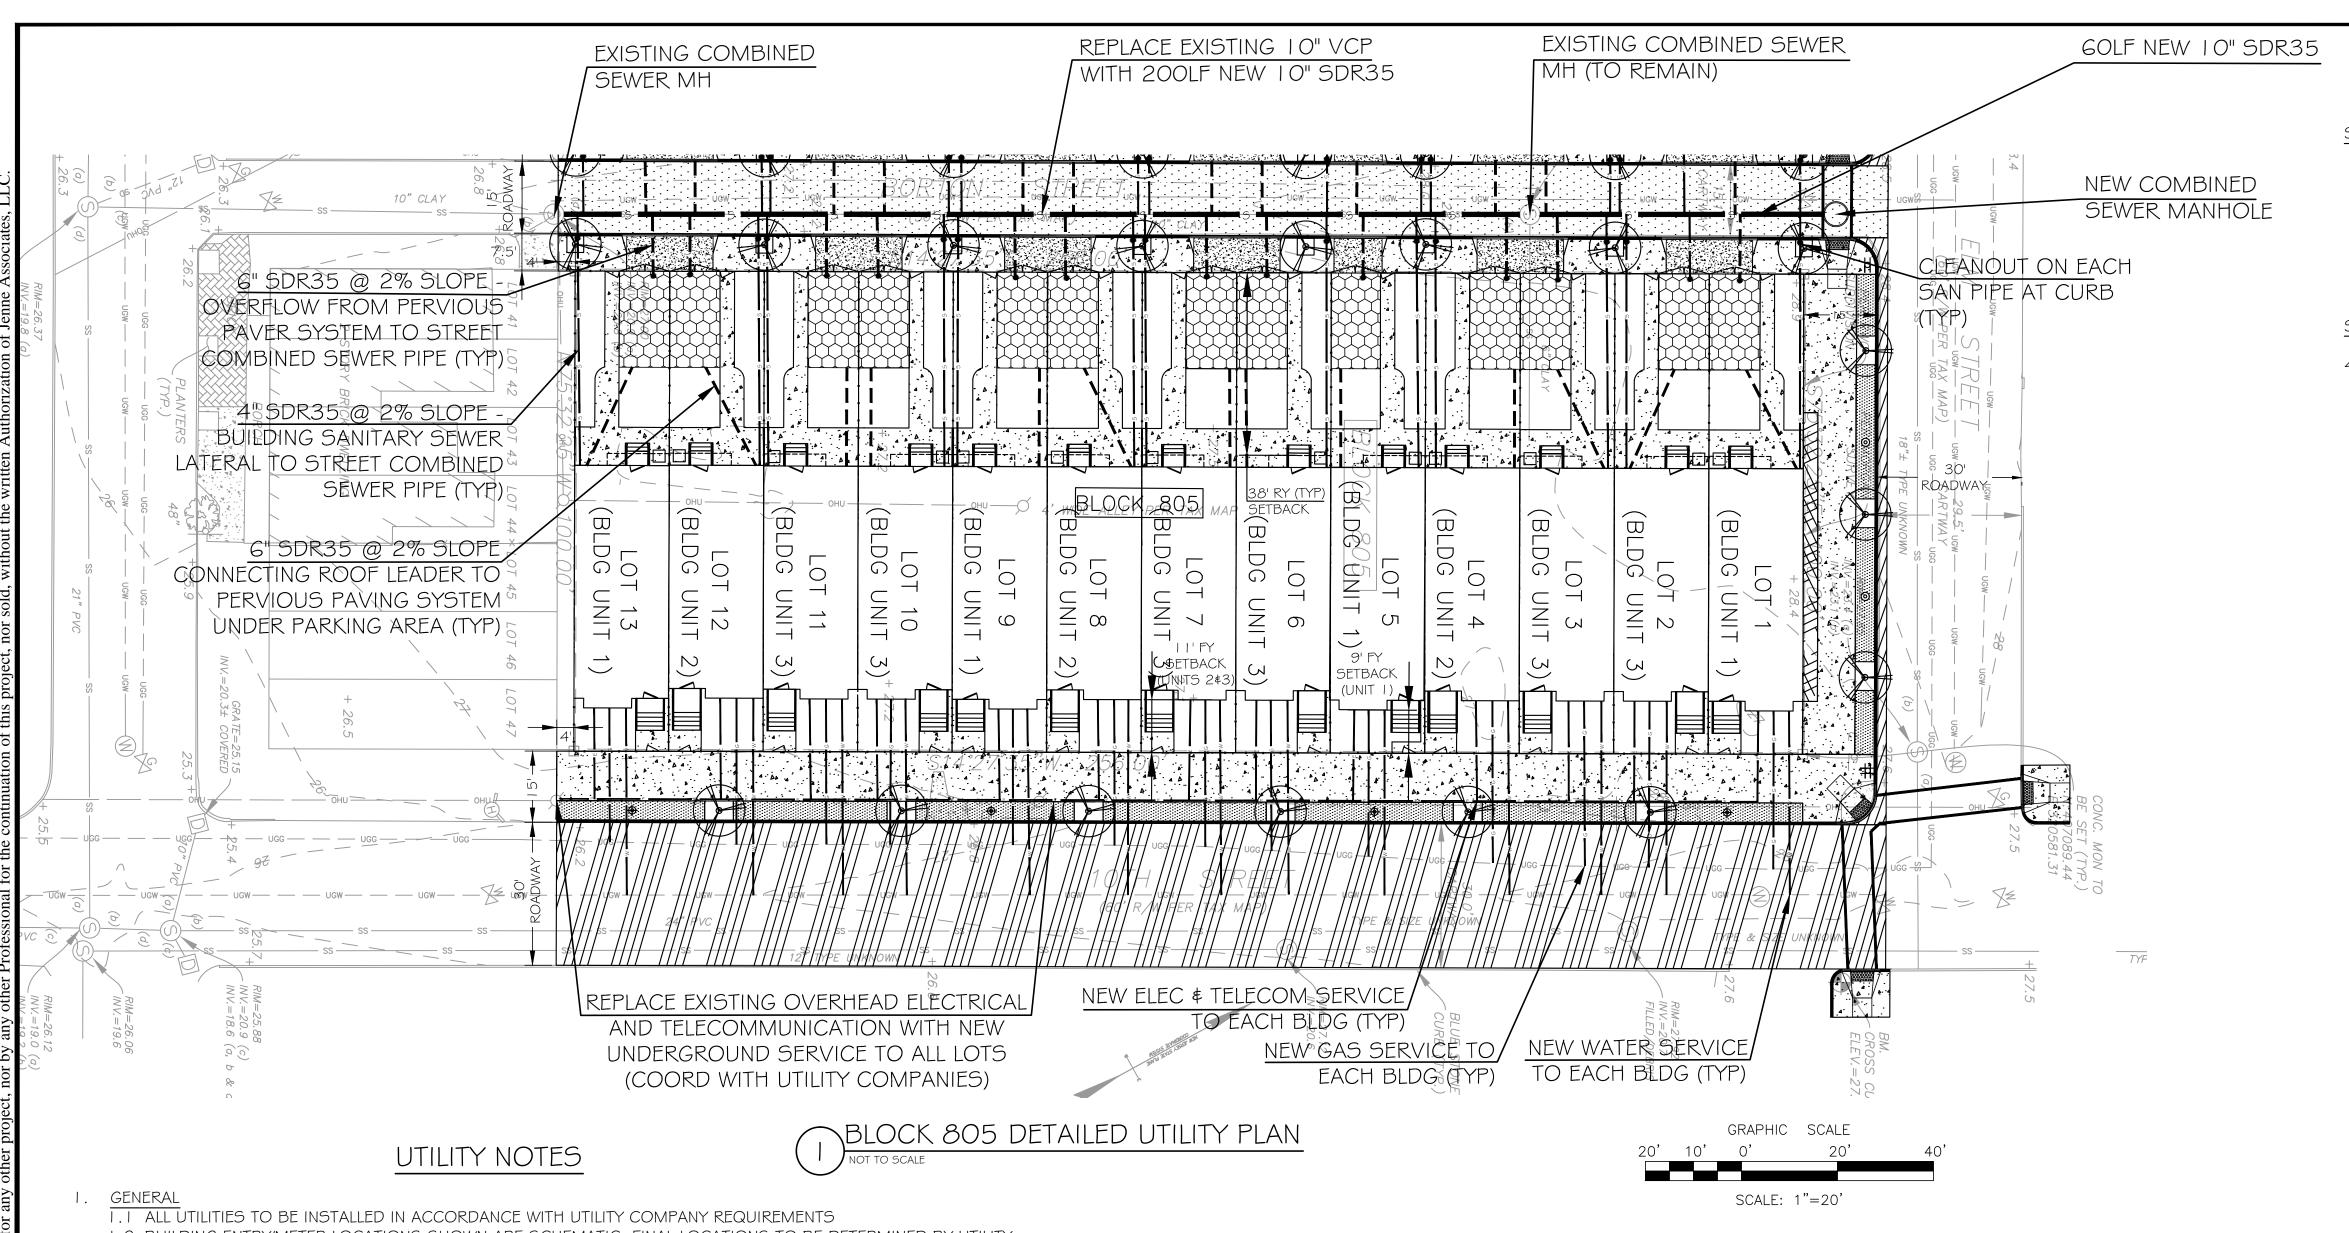TOTAL FOR PROPOSED PROJECT = 7,800 GPD

SANITARY SEWER LATERAL

4" SDR35 AT 2% MINIMUM SLOPE

SANITARY AND STORM SEWER MATERIALS

1) PVC PIPE SPEC (INCL. SDR): PIPE - ASTM D-3034, GASKETS - ASTM F-0477, JOINTS - ASTM D-3212

2) ADS PIPE SPECIFICATION: PIPE - NT-12 ST IB PIPE-ASTM F2648, GASKETS - ASTM F-0477, JOINTS - ASTM D-3212



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BLOCK #805 UTILITY PLAN

C - 302

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- 1.2 BUILDING ENTRY/METER LOCATIONS SHOWN ARE SCHEMATIC. FINAL LOCATIONS TO BE DETERMINED BY UTILITY COMPANY AND ARCHITECT.
- 1.3 LOCATION OF ALL EXISTING UNDERGROUND UTILITIES ARE APPROXIMATE AND MUST BE VERIFIED BY CONTRACTOR BEFORE START OF EXCAVATION OR CONSTRUCTION.
- 1.4 LOCATIONS OF PROPOSED UTILITY CONNECTIONS ARE APPROXIMATE. CONTRACTOR SHALL COORDINATE WITH ARCHITECT AND/OR UTILITY COMPANIES FOR EXACT LOCATION OF UTILITY CONNECTIONS PRIOR TO INSTALLATION.

WATER

- 2.1 WHEN WATER MAIN IS LOCATED WITHIN 10' HORIZONTALLY OF THE SEWER MAIN, IT SHALL BE AT LEAST 18" HIGHER OR CONCRETE ENCASED.
- 2.2 ALL EXPOSED WATER LATERALS SHALL BE INSULATED AND HEAT TRACED.

3. STORM AND SANITARY


- 3.1 COORDINATE SEWER CONNECTIONS WITH PLUMBING PLANS.
- 3.2 ALL STORM AND SANITARY SEWER LATERAL CONSTRUCTION SHALL BE DONE IN ACCORDANCE WITH THE NORTH HUDSON SEWER AUTHORITY (NHSA) REQUIREMENTS AND IN IN COMPLIANCE WITH THE PERMIT TO BE OBTAINED FOR THE PROJECT.

3. ELECTRIC AND GAS

- 4. I CONTRACTOR SHALL COORDINATE WITH THE FINAL PLUMBING PLANS FOR LOCATION OF THE BUILDING SERVICE LOCATIONS. REQUIREMENT CHANGES TO THE EXISTING ELECTRICAL AND NATURAL GAS SERVICES.
- 4.2 SERVICE CONNECTION SIZES AND INSTALLATION REQUIREMENTS SHALL BE AS REQUIRED BY THE RESPECTIVE UTILITY COMPANIES.

STORMWATER SYSTEM O&M REQUIREMENTS

- I. THE PROPERTY OWNER OF EACH INDIVIDUAL LOT IS RESPONSIBLE FOR MAINTAINING THE STORMWATER MANAGEMENT SYSTEM AND OVERFLOW PIPE FOR THAT LOT THE POINT OF CONNECTION TO THE STREET MAIN.
- 2. VISUAL INSPECTIONS SHALL BE MADE AT LEAST ANNUALLY AS WELL AS AFTER EVERY STORM EXCEEDING TWO (2) INCHES OF RAINFALL. ANY ACCUMULATED DEBRIS SHALL BE REMOVED IMMEDIATELY SO THAT IT OPERATES AS DESIGNED. ALL WORK SHOULD BE DONE BY A QUALIFIED CONTRACTOR COMPLYING WITH OSHA STANDARDS WITH REMOVAL AND DISPOSAL OF MATERIALS IN COMPLIANCE WITH ALL LOCAL, STATE AND FEDERAL LAWS.
- 3. ALL STRUCTURAL COMPONENTS MUST BE INSPECTED FOR CRACKING, SUBSIDENCE, BREACHING, WEAR AND DETERIORATION AT LEAST ANNUALLY. THE CONDITION OF THE SURROUNDING AND ABOVE LYING MATERIALS SHALL BE INSPECTED FOR EVIDENCE OF POTENTIAL FAILURES OR DETERIORATION.
- 4. ROUTINE MAINTENANCE SHOULD TYPICALLY BE UNDERTAKEN BY 2 PEOPLE FOR SAFETY CONSIDERATIONS. EQUIPMENT ANTICIPATED MAY INCLUDE A JET VACUUM VEHICLE, SHOVELS, LIGHTING EQUIPMENT AND A WHEEL BARREL OR TRUCK FOR HAULING AWAY DEBRIS. NO MANUFACTURER'S INSTRUCTIONS OR USER MANUALS ARE AVAILABLE FOR THE MAINTENANCE OF THESE COMPONENTS. WATER, MOSQUITO CONTROL CHEMICALS, PAVER OR PIPE COMPONENT REPLACEMENT MATERIALS MAY ALSO BE REQUIRED DEPENDING ON THE CONDITION OF THE COMPONENTS.
- 5. MAINTENANCE RECORDS MUST BE MAINTAINED ON-SITE FOR A MINIMUM OF THREE (3) YEARS.

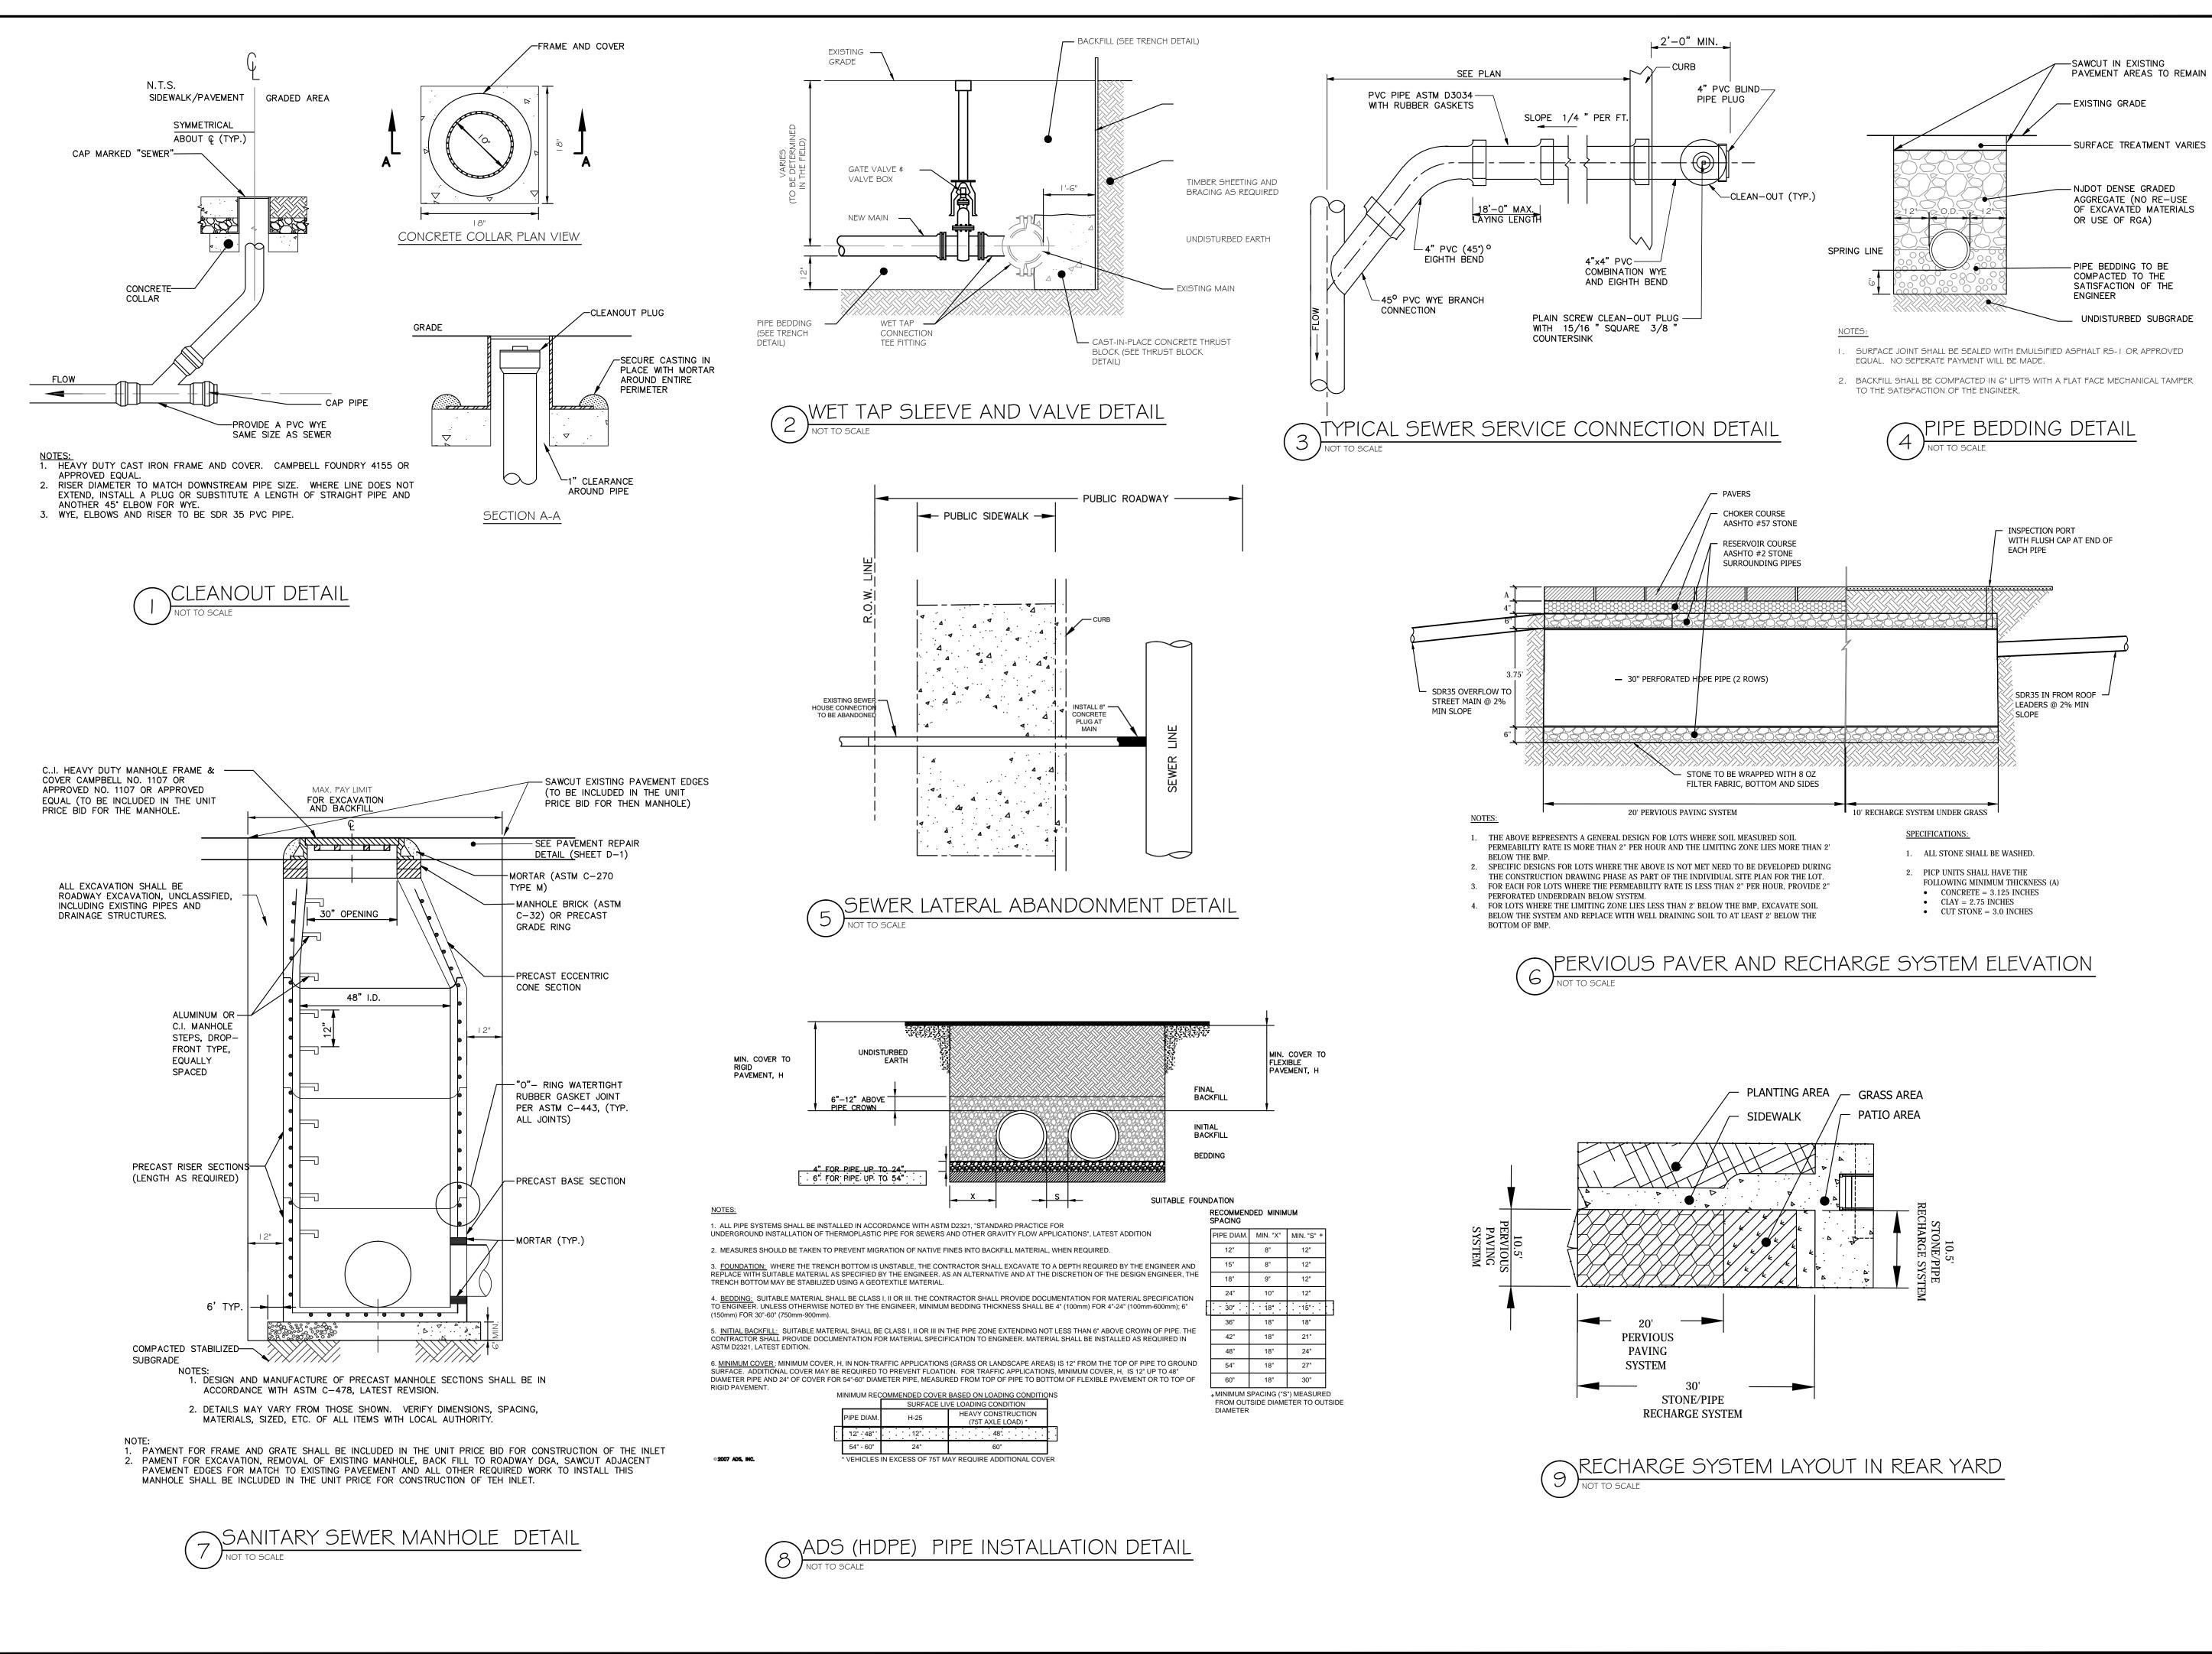

NORTH CAMDEN

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NORTH CAMDEN, NJ

Drawing Title

UTILITY DETAILS


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Project No.
23-014

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TYPICAL LANDSCAPE PLAN AT PROPOSED LOTS #2 THRU 13, BLOCKS 804 & 805.


LANDCAPING PLAN - TYPICAL

TYPICAL LANDSCAPE PLAN AT PROPOSED LOT #1, BLOCKS 804 & 805.

2 LANDCAPING PLAN - END UNITS
SCALE: 1" = 10'

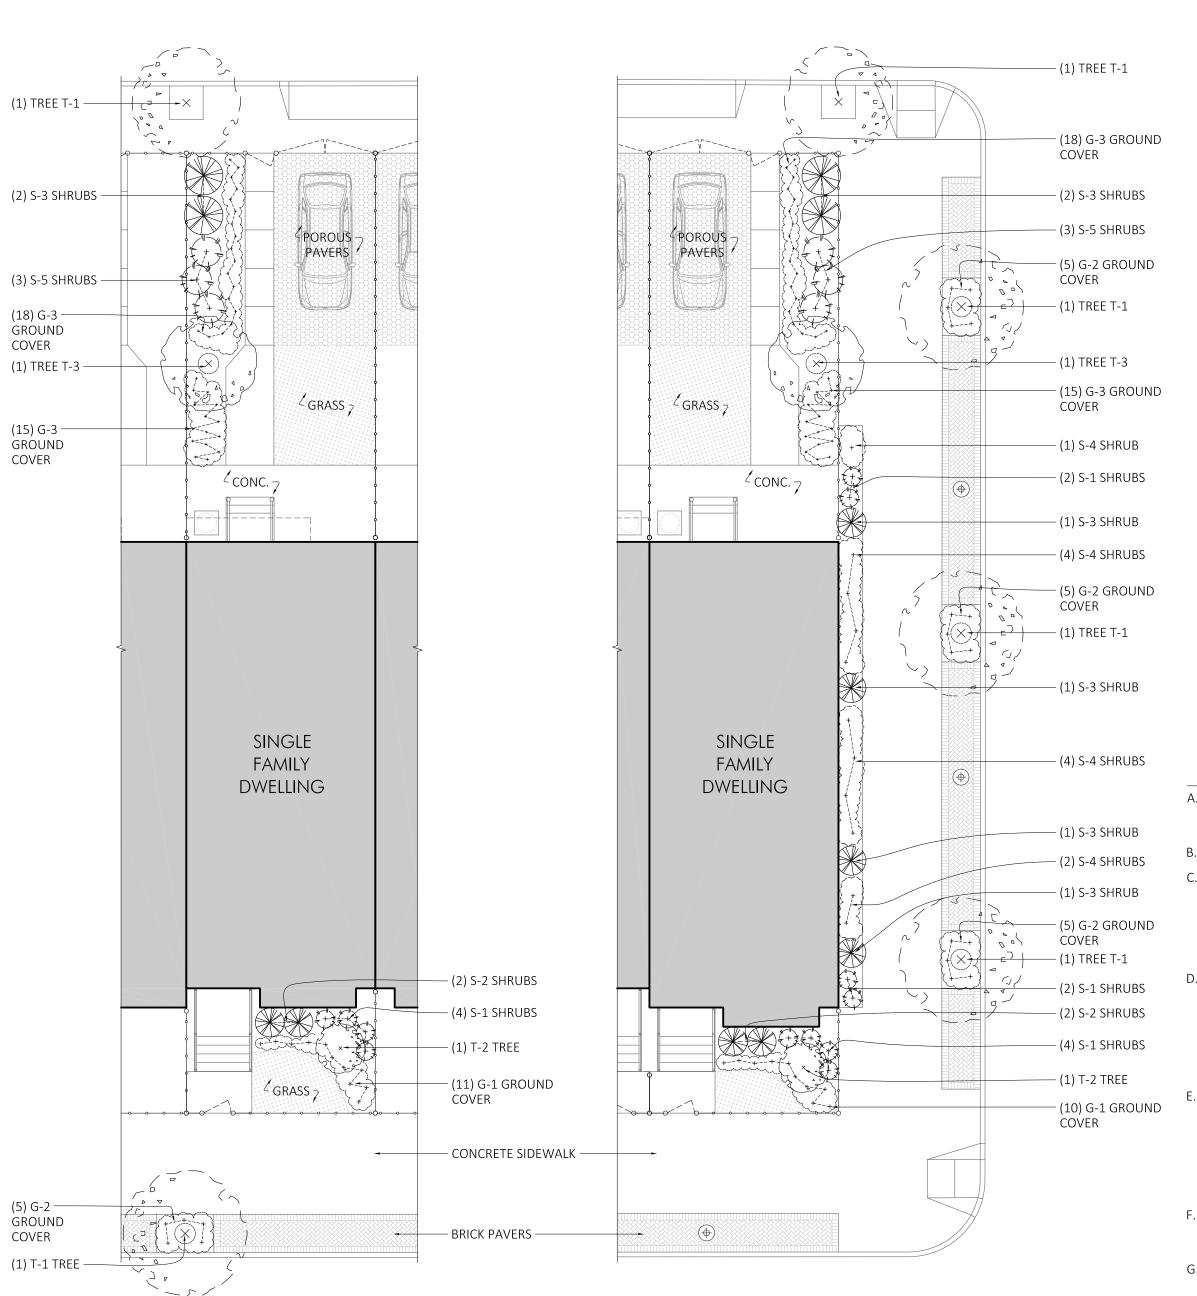LANDSCAPING SCHEDULE

TAG	TOTAL QTY. (INC. BLOCK #804 & 805)	COMMON NAME	BOTANICAL NAME	SIZE	NOTES
TREES					
T-1	35	WIRELESS ZELKOVA	ZELKOVA SERRATA 'SCHMIDTLOW'	6FT - 8FT	B+B
T-2	26	HYDRANGEA VANILLA STRAWBERRY	HYDRANGEA PANICULATA 'RENHY'	4FT - 5FT	TREE FORM
T-3	16	EMPEROR JAPANESE MAPLE	ACER PALMATUM 'WOLFF'	5FT - 6FT	B+B
SHRUB	S	1		1	
S-1	112	EARLY SUNRISE TICKSEED	COREOPSIS GRANDIFLORA 'EARLY SUNRISE'	3 GAL	
S-2	52	BUSH MONKEY FLOWER	MIMULUS AURANTIACUS	2 GAL	
S-3	60	WHITE RHODODENDRON	RHODODENDRON CATAWBIENSE ALBUM	2 GAL	
S-4	22	BABY GEM BOXWOOD	BUXUS MICROPHYLLA VAR. JANOPICA 'GREGEM'	2 GAL	
S-5	78	GREEN MOUNTAIN BOXWOOD	BUXUS x 'GREEN MOUNTAIN'	3 GAL	
GROUN	ID COVER				
G-1	284	EMERALD BLUE CREEPING PHLOX	PHLOX SUBULATA 'EMERALD BLUE'	2-1/2 PEAT POT	
G-2	95	CREEPING PHLOX	PHLOX SUBULATA 'CREEPING PHLOX'	2-1/2 PEAT POT	
G-3	858	GREEN CARPET JAPANESE SPURGE	PACHYSANDRA TERMINALIS 'GREEN CARPET'	2-1/2 PEAT POT	

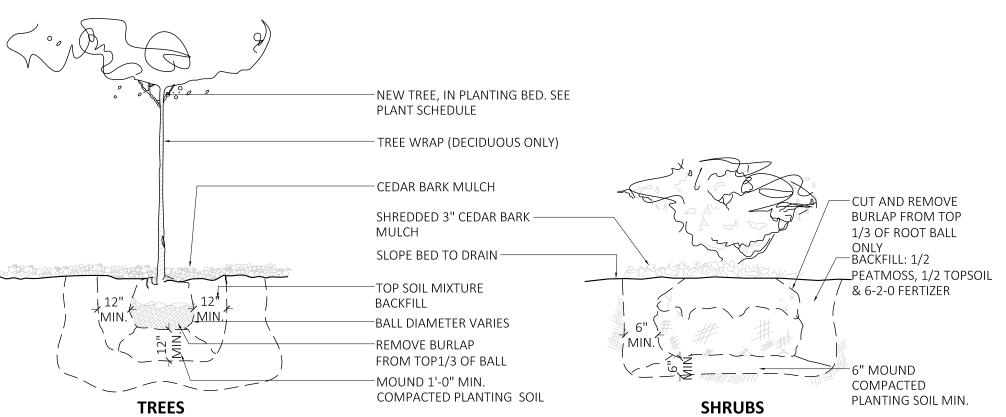

TYP. O.C. PLANTING SPACING PLANTS TO BE INSTALLED ALTERNATELY NOTES: A. PLANTS ARE TO BE SPACED EQUAL DISTANCE FROM EACH OTHER. B. REFER TO PLAN & SCHEDULE FOR SPACING OF INDIVIDUAL PLANTS. C. REMOVE ALL WIRE, PLASTIC, TAGS OR SYNTHETIC MATERIAL FROM PLANTS PRIOR TO PLANTING. -PRIOR TO PLANTING, REMOVE PLANT FROM CONTAINER & GENTLY COMB OUT ROOTS -2" MULCH LAYER, MULCH TO → VARIES → BE PLACED DOWN BEFORE **PLANTINGS** PLANTING SOIL AS SPECIFIED -UNDISTURBED SUBGRADE SECTION GROUNDCOVER

3 TYPICAL PLANTING DETAILS
SCALE: NTS

GENERAL LANDSCAPING REQUIREMENTS

- A. TREE LOCATIONS SHOWN ON PLAN TO BE VERIFIED WITH ARCHITECT IN THE FIELD, PRIOR TO PLANTING- BASED ON SCHEDULE ABOVE AND DETAILS. PROVIDE 3" PINE BARK MULCH AT ALL TREE LOCATIONS.
- B. ALL PLANTING BEDS SHALL RECEIVE 3" PINE BARK MULCH.
- C. ALL PLANTING BEDS SHALL RECEIVE MIN 6" OF TOPSOIL/PLANTING MIX OVER 12" APPROVED CLEANFILL.TOPSOIL SHALL BE NATURAL LOAM-FREE FROM SUB SOILS. TOP SOIL SHALL BE OF UNIFORM QUALITY FREE FROM CLAY, HARD PAN, SODS, STONE ASHES OR CEMENT. TOP SOIL SHALL CONTAIN AT LEAST 5% ORGANIC WATER DETERMINED BY LOSS, ON IGNITION OF MOISTURE FREE
- D. AFTER PLANTING SOAK WITH APPROVED LIQUID FERTILIZER 1/4 STRENGTH AS PER MANUFACTURER RECOMMENDATIONS. PROTECT FROM HOT SUN & STAKE W/WOOD STAKES PAINTED GREEN; 3 STAKES REQUIRED PER TREE AT 120 DEGREE SPACING, INSERT IN GROUND MIN. 12" BEFORE TYING GUYS. FERTILIZE EVERY FOUR WEEKS THROUGH GUARANTEE PERIOD. TREES SHOULD BE PLANTED SPRING THROUGH SUMMER ONLY. FOLLOW ALL RECOMMENDATIONS OF THE AMERICAN ASSOCIATION OF NURSERYMEN.
- E. USE PLANTING MIX OF 1/2 CLEAN TOPSOIL AND 1/2 CLEAN PEAT MOSS W/620 FERTILIZER ABOVE FOR NEW STREET TREE PLANTING. AFTER PLANTING, SOAK W/LIQUID FERTILIZER AT 1/4 STRENGTH THE MFG. RECOMMENDATION. PROTECT FROM HOT SUN & STAKE W/WOOD STAKES PAINTED GREEN (3 REQ'D/TREE @ 120 SPACING & FORCE VERTICAL BEFORE TYING GUYS.) FERTILIZE EVERY FOUR WEEKS THROUGH FIRST SIX MONTHS OR THROUGH GUARANTEE PERIOD WHERE APPLICABLE.
- F. PLANTING QUANTITIES AND LOCATIONS ON THIS SHEET ARE APPROXIMATE, FOR GENERAL DESCRIPTIVE PURPOSES, AND SHALL BE CONSIDERED THE MINIMUM REQUIRED. THE SCHEDULE SHALL PREVAIL.
- G. MAINTENANCE PLAN SHALL INCLUDE: ADULT GROWTH SHALL BE MAINTAINED AT A 4' HEIGHT MINIMUM.

GRASS MIX NOTES

- 1. PRIOR TO SEEDING, AREA IS TO BE TOPSOILED, FINE GRADED, AND RAKED OF ALL DEBRIS LARGER THAN 2" DIAMETER.
- 2. THE FOLLOWING SEED MIX SHALL BE SOWN AT THE RATES AS SPECIFIED:

RED FESCUE 1 1/2 LBS / 1,000 SF PERENNIAL RYEGRASS 1 LB / 1,000 SF

KENTUCKY BLUEGRASS 1 1/2 LBS / 1,000 SF


SPREADING FESCUE 1 LB / 1,000 SF

- 3. SEEDED LAWN AREAS SHALL BE MULCHED TO PRESERVE SOIL MOISTURE AND PREVENT EROSION DURING THE ESTABLISHMENT PERIOD UNTIL A STAND OF COVER IS ACCEPTED BY THE OWNER.
- 4. SEEDING DATES FOR THIS MIXTURE SHALL BE AS FOLLOWS: SPRING APRIL 1 - MAY 31

FALL AUGUST 16 - OCTOBER 31

5. GERMINATION RATES WILL VARY AS TO TIME OF YEAR FOR SOWING. CONTRACTOR SHALL IRRIGATE SEEDED AREA UNTIL AN ACCEPTABLE STAND OF COVER IS ESTABLISHED BY OWNER.

FENCING & GATES SHALL BE WELDED METAL, PAINTED BLACK. A 4" Ø SPHERE SHALL NOT PASS THRU PICKETS @ ANY POINT

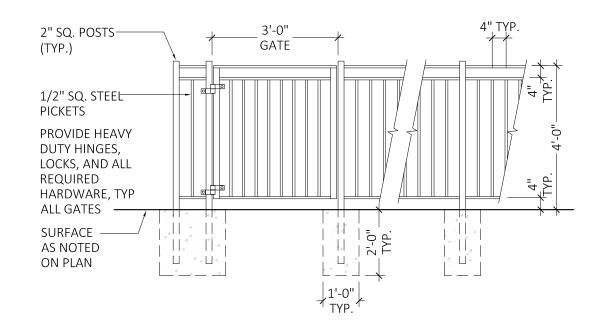

TYPICAL FENCING/GATE DETAIL

SCALE: 3/8" = 1'-0"

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CASAS DEL RIO

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CASAS DEL RIO CAMDEN LUTHERAN HOUSING INC. NORTH CAMDEN, NJ

Drawing Title


LANDSCAPE PLAN, **NOTES & DETAILS**

Drawing No.

MICHAEL I. MILLA Project No. 23-014 AS NOTED Drawn/Checked by

NS/MM

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1. TEMPORARY STABILIZATION SPECIFICATIONS

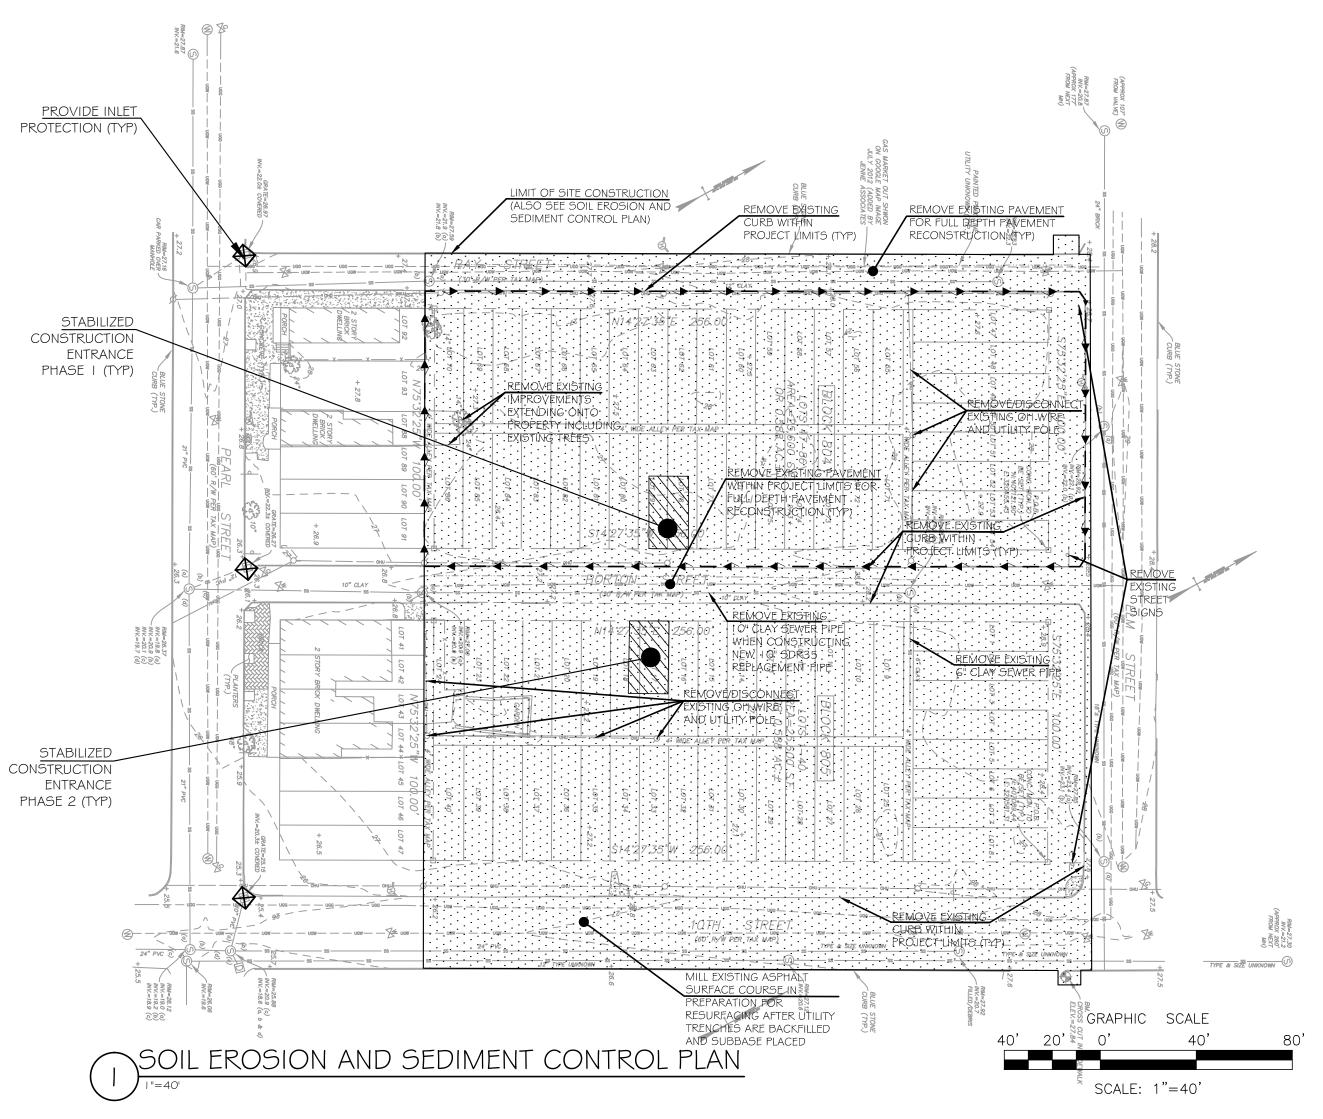a) APPLY GROUND LIMESTONE AT A RATE OF 90 LBS. PER 1000 SQ. FT. b) APPLY FERTILIZER (10-20-10) AT A RATE OF 11 LBS. PER 1000 SQ. FT.

c) APPLY PERENNIAL RYE GRASS SEED AT 1 LBS. PER 1000 SQ. FT. AND ANNUAL RYEGRASS AT 1 LBS. PER 1000 SQ.

d) MULCH WITH STRAW OR HAY AT A RATE OF 90 LBS. PER 1000 SQ. FT.

e) ACCEPTABLE MULCH ANCHORING: 1) LIQUID MULCH BINDER, 2) PEG AND TWINE, AND 3) MULCH NETTING.

2. PERMANENT STABILIZATION SPECIFICATIONS

a) APPLY TOPSOIL TO A DEPTH OF 5 INCHES (UNSETTLED).

b) APPLY GROUND LIMESTONE AT A RATE OF 90 LBS. PER 1000 SQ. FT. AND WORK 4 INCHES INTO SOIL. c) APPLY FERTILIZER (10-20-10) AT A RATE OF 11 LBS. PER 1000 SQ. FT.

d) APPLY HARD FESCUE SEED AT 2.7 LBS. PER 1000 SQ. FT. AND CREEPING RED FESCUE SEED AT 0.7 LBS. PER 1000 SQ. FT. AND PERENNIAL RYEGRASS SEED AT 0.25 LBS. PER 1000 SQ. FT. (OPTIMAL SEEDING DATES ARE

2/15-4/30 AND 8/15-10/30). e) APPLY GROUND LIMESTONE AT A RATE OF 90 LBS. PER 1000 SQ. FT.

f) MULCH WITH STRAW OR HAY AT A RATE OF 90 LBS. PER 1000 SQ. FT. g) ACCEPTABLE MULCH ANCHORING: 1) LIQUID MULCH BINDER, 2) PEG AND TWINE, AND 3) MULCH NETTING.

DUST CONTROL NOTES

AS PER THE STANDARDS FOR SOIL EROSION AND SEDIMENT CONTROL IN NEW JERSEY, JULY 1999. THE FOLLOWING METHODS SHOULD BE CONSIDERED FOR CONTROLLING DUST:

MULCHES - SEE STANDARD FOR STABILIZATION WITH MULCHES ONLY (PG. 5-1)

VEGETATIVE COVER - SEE STANDARDS FOR TEMPORARY VEGETATIVE COVER (PG. 7-1), PERMANCE VEGETATIVE COVER FOR SOIL STABALIZATION

SPRAY-ON ADHESIVES - ON MINERAL SOILS (NOT EFFECTIVE ON MUCK SOILS) KEEP TRAFFIC OFF THESE AREAS

TABLE 16-1: DUST CONTROL MATERIALS

MATERIAL	WATER DILUTION	TYPE OF NOZZLE	APPLY (GAL/ACRE)		
ANIONIC ASPHALT EMULSION	7:1	COARSE SPRAY	1,200		
LATEX EMULSION	12.5:1	FINE SPRAY	235		
RESIN IN WATER	4:1	FINE SPRAY	300		
POLYACRYLAMIDE (PAM) - SPRAY ON	MAY ALSO BE USED AS AN ADDITIVE TO SEDIMENT BASINS TO FLOCCULATE				
POLYACRYLAMIDE (PAM) - DRY SPRAY	PRECIPITATE SUSPENDED COLLOIDS. SEE SEDIMENT BASIN STANDARDS (PG. 26-1) APPLY ACCORDING TO MANUFACTURE'S INSTRUCTIONS				
ACIDULATED SOY BEAN SOAP STICK	NONE COARSE SPRAY 1,200				

TILLAGE - TO ROUGHEN SURFACE AND BRING CLODS TO THE SURFACE. THIS IS A TEMPORARY EMERGENCY MEASURE WHICH SHOULD BE USED BEFORE SOIL BLOWING STARTS. BEGIN PLOWING ON WINDWARD SIDE OF TEH SITE CHISEL—TYPE PLOWS SPACE ABOUT 12 INCHES APART, AND SPRING-TOOTHED HARROWS ARE EXAMPLES OF EQUIPMENT WHICH MAY PRODUCE THE DESIRED EFFECT.

SPRINKLING - SITE IS SPRINKLED UNTIL THE SURFACE IS WET

BARRIERS - SOLID BOARD FENCES, BURLAP FENCES, CRATE WALLS, BALES OF HAY, AND SIMILAR MATRIAL CAN BE USED TO CONTROL AIR CURRENTS AND SOIL BLOWING.

CALCIUM CHLORIDE — SHALL BE IN THE FORM OF LOOSE, DRY GRANULATES OF FLAKES FINE ENOUGH TO FEED THROUGH COMMONLY USED SPREADERS AT A RATE THAT WILL KEEP SURFACE MOIST BUT NOT CAUSE POLLUTION OR PLANT DAMAGE. IF USED ON STEEPER SLOPES, THEN USE OTHER PRACTICES TO PREVENT WASHING INTO STREAMS, OR ACCUMULATION AROUND PLANTS.

STONE - COVER SURFACE WITH CRUSHED STONE OR COARSE GRAVEL.

SEQUENCE OF CONSTRUCTION

THE CAMDEN SOIL CONSERVATION DISTRICT SHALL BE NOTIFIED IN WRITING AT LEASE 72 HOURS PRIOR TO ANY SOIL DISTURBING ACTIVITIES.

PHASE I - CONSTRUCTION (BLOCK 804)

I. INSTALL SILT FENCING, STABILIZED CONSTRUCTION ENTRANCE AND INLET PROTECTION WHERE REQUIRED - I WEEK

2. UNDERTAKE SITE DEMOLITION - 2 WEEKS

3. STAKEOUT CURB/SIDEWALK AND CONSTRUCT NEW CURBS - 4 WEEKS

4. INSTALL UNDERGROUND UTILITY SERVICES FROM THE STREET TO THE PROPERTY LINES - 6 WEEKS

5. REPAIR/RECONSTRUCT RAY AND ELM STREET ROADWAYS (TO BASE COURSE) - 3 WEEKS 6. CONSTRUCT INDIVIDUAL HOUSES WITH SITE IMPROVEMENTS AND UTILITY CONNECTIONS - 12 MONTHS

7. INSTALL SIDEWALKS, STREET TREES AND LIGHTING - 8 WEEKS

8. COMPLETE SITE LANDSCAPING AND HOUSE FINISH WORK - 6 WEEKS 9. COMPLETE FINISH PAVEMENT COURSE ON RAY AND ELM STREETS - 2 WEEKS.

I O.CALL CAMDEN SCD FOR FINAL INSPECTION. REMOVE SOIL EROSION AND SEDIMENT CONTROL MEASURES ONLY AFTER FINAL CAMDEN SCD APPROVAL.

I I . TOTAL CONTINUOUS TIME ESTIMATE FOR PHASE I - 18 MONTHS

PHASE 2 - CONSTRUCTION (BLOCK 805)

I. INSTALL SILT FENCING, STABILIZED CONSTRUCTION ENTRANCE AND INLET PROTECTION WHERE REQUIRED - I WEEK

2. UNDERTAKE SITE DEMOLITION - 2 WEEKS

3. STAKEOUT CURB/SIDEWALK AND CONSTRUCT NEW CURBS - 4 WEEKS

4. INSTALL UNDERGROUND UTILITY SERVICES FROM THE STREET TO THE PROPERTY LINES - 6 WEEKS

5. REPAIR/RECONSTRUCT BORTON, NORTH 10TH AND ELM STREET ROADWAYS (TO BASE COURSE) - 5 WEEKS

6. CONSTRUCT INDIVIDUAL HOUSES WITH SITE IMPROVEMENTS AND UTILITY CONNECTIONS - 12 MONTHS

7. INSTALL SIDEWALKS, STREET TREES AND LIGHTING - 8 WEEKS 8. COMPLETE SITE LANDSCAPING AND HOUSE FINISH WORK - 6 WEEKS

9. COMPLETE FINISH PAVEMENT COURSE ON BORTON, NORTH 10TH AND ELM STREET - 2 WEEKS.

IO.CALL CAMDEN SCD FOR FINAL INSPECTION. REMOVE SOIL EROSION AND SEDIMENT CONTROL MEASURES ONLY AFTER FINAL CAMDEN SCD APPROVAL.

I I.TOTAL CONTINUOUS TIME ESTIMATE FOR PHASE 2 - 18 MONTHS

CAMDEN COUNTY SCD NOTES

- 1. ALL APPLICABLE EROSION AND SEDIMENT CONTROL PRACTICES SHALL BE IN PLACE PRIOR TO ANY GRADING OPERATION AND/OR INSTALLATION OF PROPOSED STRUCTURES OR UTILITIES.
- 2. SOIL EROSION AND SEDIMENT CONTROL PRACTICES ON THIS PLAN SHALL BE CONSTRUCTED IN ACCORDANCE WITH THE STANDARDS FOR SOIL EROSION AND SEDIMENT CONTROL IN NEW JERSEY.
- 3. APPLICABLE EROSION AND SEDIMENT CONTROL PRACTICES SHALL BE LEFT IN PLACE UNTIL CONSTRUCTION IS COMPLETED AND/OR THE AREA IS STABILIZED.
- 4. THE CONTRACTOR SHALL PERFORM ALL WORK, FURNISH ALL MATERIALS AND INSTALL ALL MEASURES REQUIRED TO REASONABLY CONTROL SOIL EROSION RESULTING FROM CONSTRUCTION OPERATIONS AND PREVENT EXCESSIVE FLOW OF SEDIMENT FROM THE CONSTRUCTION SITE
- 5. ANY DISTURBED AREA THAT IS TO BE LEFT EXPOSED FOR MORE THAN THIRTY (30) DAYS AND NOT SUBJECT TO CONSTRUCTION TRAFFIC SHALL IMMEDIATELY RECEIVE A TEMPORARY SEEDING AND WILL BE MULCHED WITH SALT HAY OR EQUIVALENT AND ANCHORED IN ACCORDANCE WITH THE NEW JERSEY STANDARDS (I.E. PEG AND TWINE, MULCH NETTING OR LIQUID MULCH BINDER).
- 6. IT SHALL BE THE RESPONSIBILITY OF THE DEVELOPER TO PROVIDE CONFIRMATION OF LIME, FERTILIZER AND SEED APPLICATION AND RATES OF APPLICATION AT THE REQUEST OF THE CAMDEN COUNTY SOIL CONSERVATION DISTRICT.
- 7. ALL CRITICAL AREAS SUBJECT TO EROSION WILL RECEIVE A TEMPORARY SEEDING IN COMBINATION WITH STRAW MULCH AT A RATE OF 2 TONS PER ACRE, ACCORDING TO THE NEW JERSEY STANDARDS IMMEDIATELY FOLLOWING ROUGH GRADING
- 8. THE SITE SHALL AT ALL TIMES BE GRADED AND MAINTAINED SUCH THAT ALL STORMWATER RUNOFF IS DIVERTED TO SOIL EROSION AND SEDIMENT CONTROL FACILITIES.
- 9. ALL SEDIMENTATION STRUCTURES WILL BE INSPECTED AND MAINTAINED ON A REGULAR BASIS AND AFTER EVERY STORM EVENT.
- 10. A CRUSHED STONE, TIRE CLEANING PAD WILL BE INSTALLED WHEREVER A CONSTRUCTION ACCESS EXISTS. THE STABILIZED PAD WILL BE INSTALLED ACCORDING TO THE STANDARD FOR STABILIZED
- 11. ALL DRIVEWAYS MUST BE STABILIZED WITH 2 ½" CRUSHED STONE OR SUBBASE PRIOR TO INDIVIDUAL LOT CONSTRUCTION.
- 12. PAVED ROADWAYS MUST BE KEPT CLEAN AT ALL TIMES.
- 13. ALL CATCH BASIN INLETS WILL BE PROTECTED ACCORDING TO THE CERTIFIED PLAN.
- 14. ALL STORM DRAINAGE OUTLETS WILL BE STABILIZED, AS REQUIRED, BEFORE THE DISCHARGE POINTS
- 15. ALL DEWATERING OPERATIONS MUST DISCHARGE DIRECTLY INTO A SEDIMENT FILTER AREA. THE SEDIMENT FILTER SHOULD BE COMPOSED OF A SUITABLE SEDIMENT FILTER FABRIC. (SEE DETAIL) THE BASIN MUST BE DEWATERED TO NORMAL POOL WITHIN 10 DAYS OF THE DESIGN STORM.
- 16. NJSA 4:24-39, ET SEQ. REQUIRES THAT NO CERTIFICATE OF OCCUPANCY BE ISSUED BEFORE ALL WITH FOR PERMANENT MEASURES. ALL SITE WORK FOR THE PROJECT MUST BE COMPLETED PRIOR TO THE DISTRICT ISSUING A REPORT OF COMPLIANCE AS A PREREQUISITE TO THE ISSUANCE OF A CERTIFICATE OF OCCUPANCY BY THE MUNICIPALITY.
- 17. MULCHING IS REQUIRED ON ALL SEEDED AREAS TO INSURE AGAINST EROSION BEFORE GRASS IS ESTABLISHED TO PROMOTE EARLIER VEGETATION COVER.
- 18. OFFSITE SEDIMENT DISTURBANCE MAY REQUIRE ADDITIONAL CONTROL MEASURES TO BE DETERMINED BY THE EROSION CONTROL INSPECTOR.
- 19. A COPY OF THE CERTIFIED SOIL EROSION AND SEDIMENT CONTROL PLAN MUST BE MAINTAINED ON THE PROJECT SITE DURING CONSTRUCTION.
- 20. THE CAMDEN COUNTY SOIL CONSERVATION DISTRICT SHALL BE NOTIFIED 72 HOURS PRIOR TO ANY LAND DISTURBANCE.
- 21. ANY CONVEYANCE OF THIS PROJECT PRIOR TO ITS COMPLETION WILL TRANSFER FULL RESPONSIBILITY FOR COMPLIANCE WITH THE CERTIFIED PLAN TO ANY SUBSEQUENT OWNERS.
- 22. IMMEDIATELY AFTER THE COMPLETION OF STRIPPING AND STOCKPILING OF TOPSOIL, THE STOCKPILE MUST BE STABILIZED ACCORDING TO THE STANDARD FOR TEMPORARY VEGETATIVE COVER. STABILIZE TOPSOIL PILE WITH STRAW MULCH FOR PROTECTION IF THE SEASON DOES NOT PERMIT THE APPLICATION AND ESTABLISHMENT OF TEMPORARY SEEDING. ALL SOIL STOCKPILES ARE NOT TO BE LOCATED WITHIN FIFTY (50) FEET OF A FLOODPLAIN, SLOPE, ROADWAY OR DRAINAGE FACILITY AND THE BASE MUST BE PROTECTED WITH A SEDIMENT BARRIER.
- 23. ANY CHANGES TO THE SITE PLAN WILL REQUIRE THE SUBMISSION OF A REVISED SOIL EROSION AND SEDIMENT CONTROL PLAN TO THE CAMDEN COUNTY SOIL CONSERVATION DISTRICT. THE REVISED PLAN MUST BE IN ACCORDANCE WITH THE CURRENT NEW JERSEY STANDARDS FOR SOIL EROSION AND SEDIMENT CONTROL.
- 24. METHODS FOR THE MANAGEMENT OF HIGH ACID PRODUCING SOILS SHALL BE IN ACCORDANCE WITH THE STANDARDS. HIGH ACID PRODUCING SOILS ARE THOSE FOUND TO CONTAIN IRON SULFIDES OR HAVE A pH OF 4 OR LESS.
- 25. TEMPORARY AND PERMANENT SEEDING MEASURES MUST BE APPLIED ACCORDING TO THE NEW JERSEY STANDARDS, AND MULCHED WITH SALT HAY OR EQUIVALENT AND ANCHORED IN ACCORDANCE WITH THE NEW JERSEY STANDARDS (I.E. PEG AND TWINE, MULCH NETTING OR LIQUID MULCH BINDER).
- 26. MAXIMUM SIDE SLOPES OF ALL EXPOSED SURFACES SHALL NOT BE CONSTRUCTED STEEPER THAN 3:1 UNLESS OTHERWISE APPROVED BY THE DISTRICT.
- 27. DUST IS TO BE CONTROLLED BY AN APPROVED METHOD ACCORDING TO THE NEW JERSEY STANDARDS AND MAY INCLUDE WATERING WITH A SOLUTION OF CALCIUM CHLORIDE AND WATER.
- 28. ADJOINING PROPERTIES SHALL BE PROTECTED FROM EXCAVATION AND FILLING OPERATIONS ON THE
- 29. USE STAGED CONSTRUCTION METHODS TO MINIMIZE EXPOSED SURFACES, WHERE APPLICABLE.
- 30. ALL VEGETATIVE MATERIAL SHALL BE SELECTED IN ACCORDANCE WITH AMERICAN STANDARDS FOR NURSERY STOCK OF THE AMERICAN ASSOCIATION OF THE NURSERYMEN AND IN ACCORDANCE WITH
- 31. NATURAL VEGETATION AND SPECIES SHALL BE RETAINED WHERE SPECIFIED ON THE LANDSCAPE PLAN
- 32. THE SOIL EROSION INSPECTOR MAY REQUIRE ADDITIONAL SOIL EROSION MEASURES TO BE INSTALLED, AS DIRECTED BY THE DISTRICT INSPECTOR.

AREA OF DISTURBANCE = 82,955 SF

SOIL COMPACTION NOTES

I. THIS PROJECT IS EXEMPT FROM THE SOIL COMPACTION MITIGATION REQUIREMENT OF THE LAND GRADING STANDARD FOR THE FOLLOWING REASONS:

A. THE PROJECT IS LOCATED IN AN URBAN REDEVELOPMENT AREA (

APPLICANT

CAMDEN LUTHERAN HOUSING, INC. 800 GALINDEZ COURT CAMDEN, NJ 08102



CITY OF CAMDEN, NJ

CAMDEN LUTHERAN HOUSING INC.

137 Lake Road Valley Cottage, NY 10989

35 Gates Avenue, Warren, NJ 07059 Tel: (908) 698-2890 Fax: (908) 926-2359 NJ Certificate of Authorization for Engineering 24GA28135000



DATE ISSUE DESCRIPTION PLANNING BD. SUBMISSION

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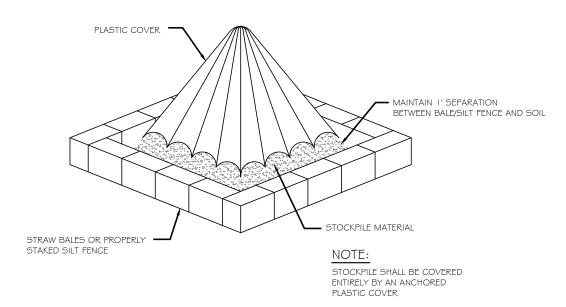
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Drawing Title

SOIL EROSION AND SEDIMENT CONTROL PLAN


MICHAEL I. MILLA

CAJ/CJ




SOIL STOCKPILE PROTECTION DETAIL


NOT TO SCALE

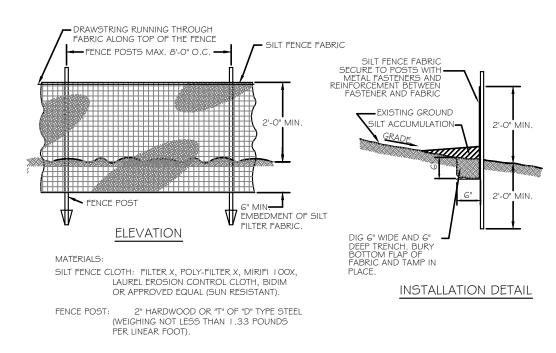

SILT FENCE DETAIL NOT TO SCALE

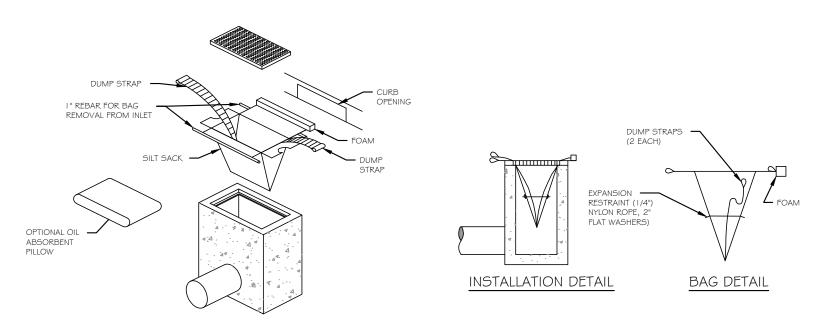

INLET PROTECTION DETAIL

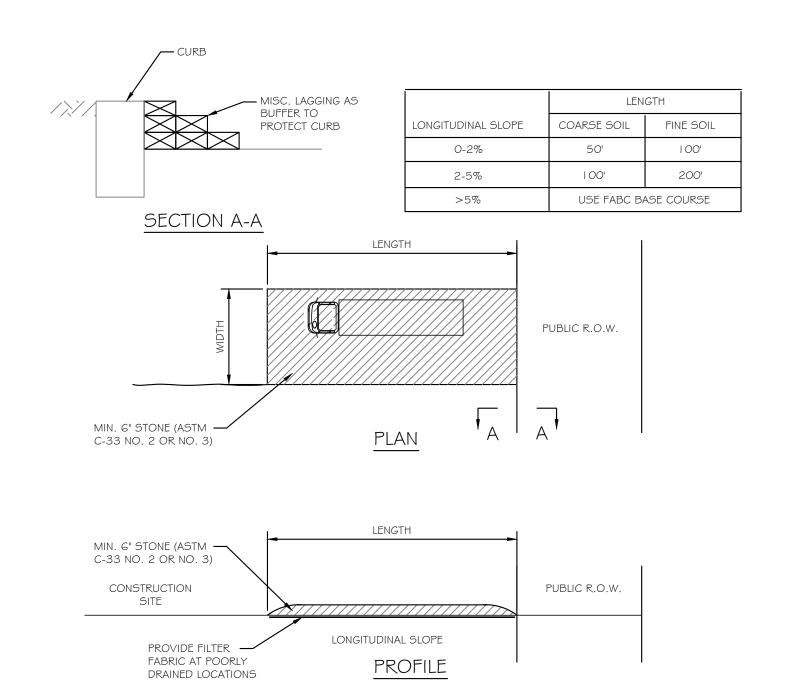

STABILIZED CONSTRUCTION ENTRANCE DETAIL

<u>APPLICANT</u>

CASAS DEL RIO CAMDEN LUTHERAN HOUSING, INC. 800 GALINDEZ COURT CAMDEN, NJ 08102

CASAS DEL RIO

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Valley Cottage, NY 10989

Civil Engineer

Jenne Associates, LLC

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Drawing Title

SOIL EROSION AND SEDIMENT CONTROL PLAN DETAILS

Drawing N

SESC-102

MICHAEL I. MILLA

Project No. 23-014

AS NOTED

Drawn/Checked by CAJ/CJ
NJ LIC. No. 22414



ARCHITECTURAL RENDERING - N. 10th STREET

SCALE: NTS



CAMDEN LUTHERAN HOUSING INC.

Milla Architecture Studio
137 Lake Road
Valley Cottage, NY 10989

Civil Engineer

JENNE ASSOCIATES, LLC Consulting Engineers 35 Gates Avenue Warren, NJ 07059

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Drawing Title

ARCHITECTURAL RENDERING **VIEW ALONG** N. 10th STREET

Drawing No.


MICHAEL I. MILLA Project No. 23-014 AS NOTED

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Archite

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Civil Engineer

JENNE ASSOCIATES, LLC Consulting Engineers 35 Gates Avenue Warren, NJ 07059

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CAMDEN LUTHERAN HOUSING INC.
NORTH CAMDEN, NJ

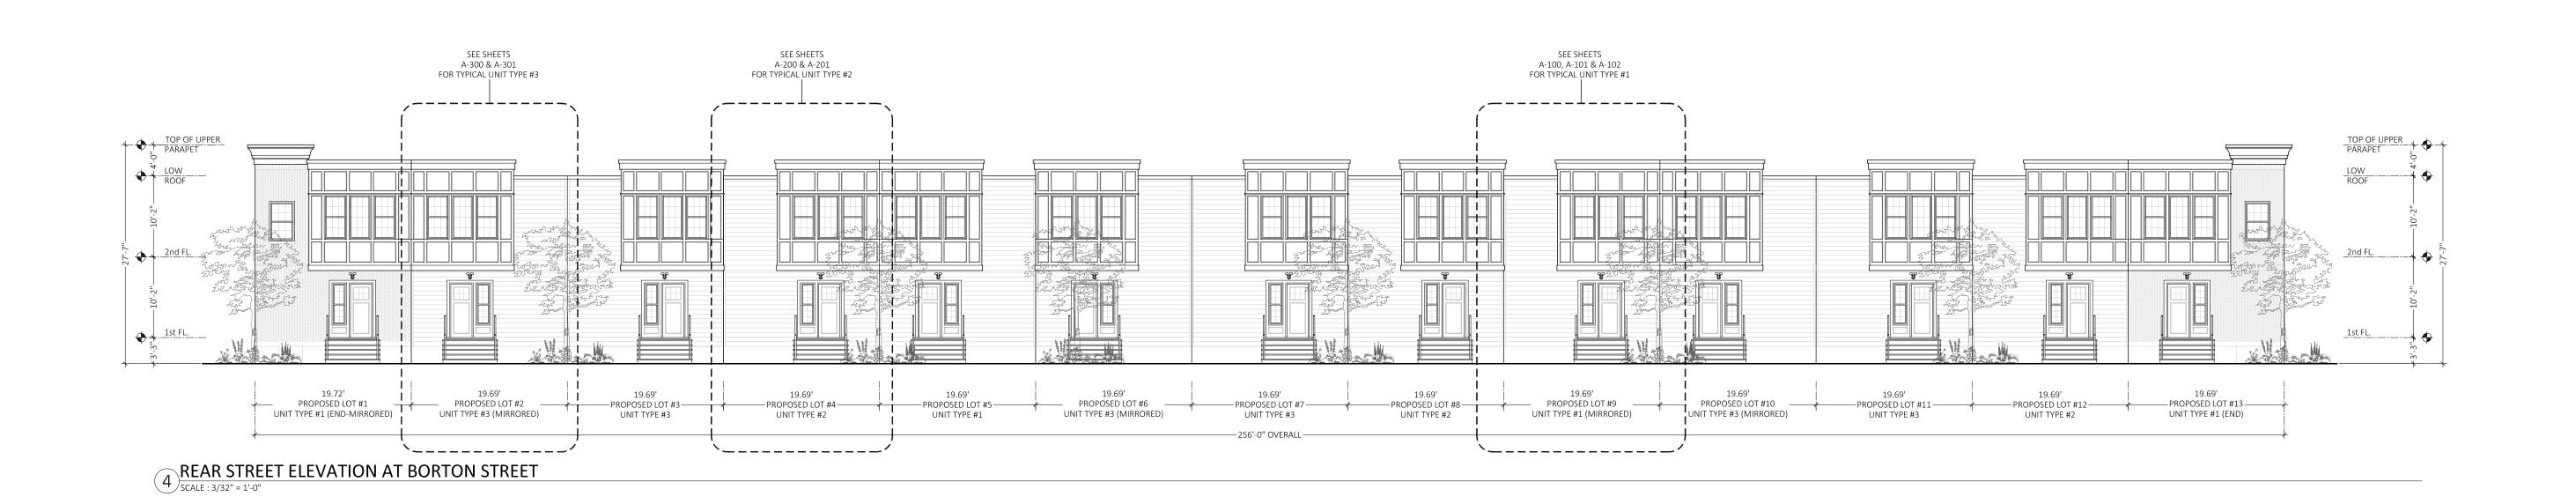Drawing Title

BUILDING/ STREET ELEVATIONS

Drawing No.

A-02


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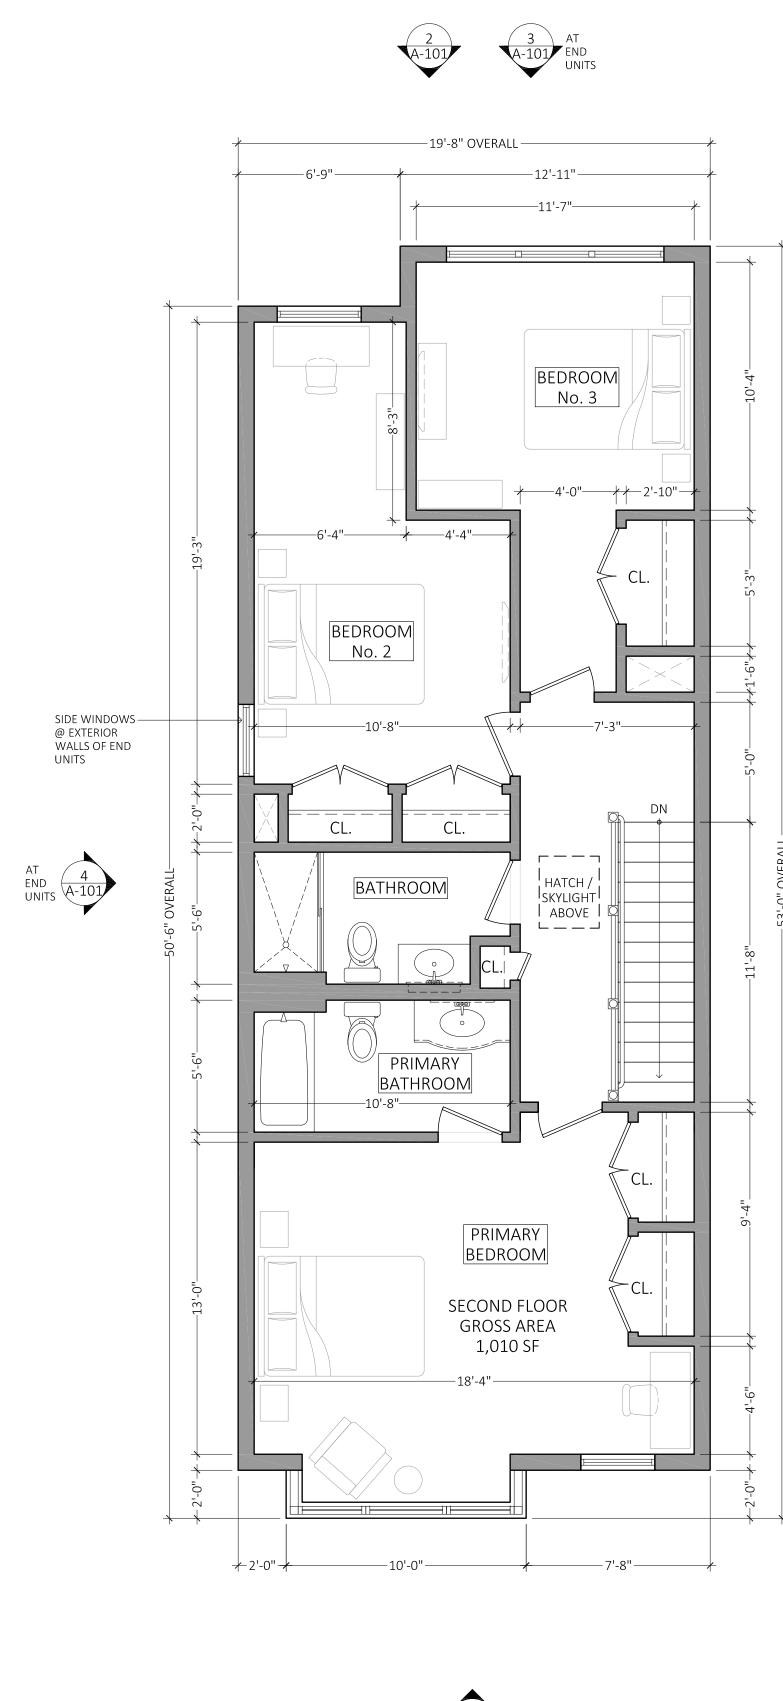
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NS/MM







CAMDEN LUTHERAN HOUSING INC.

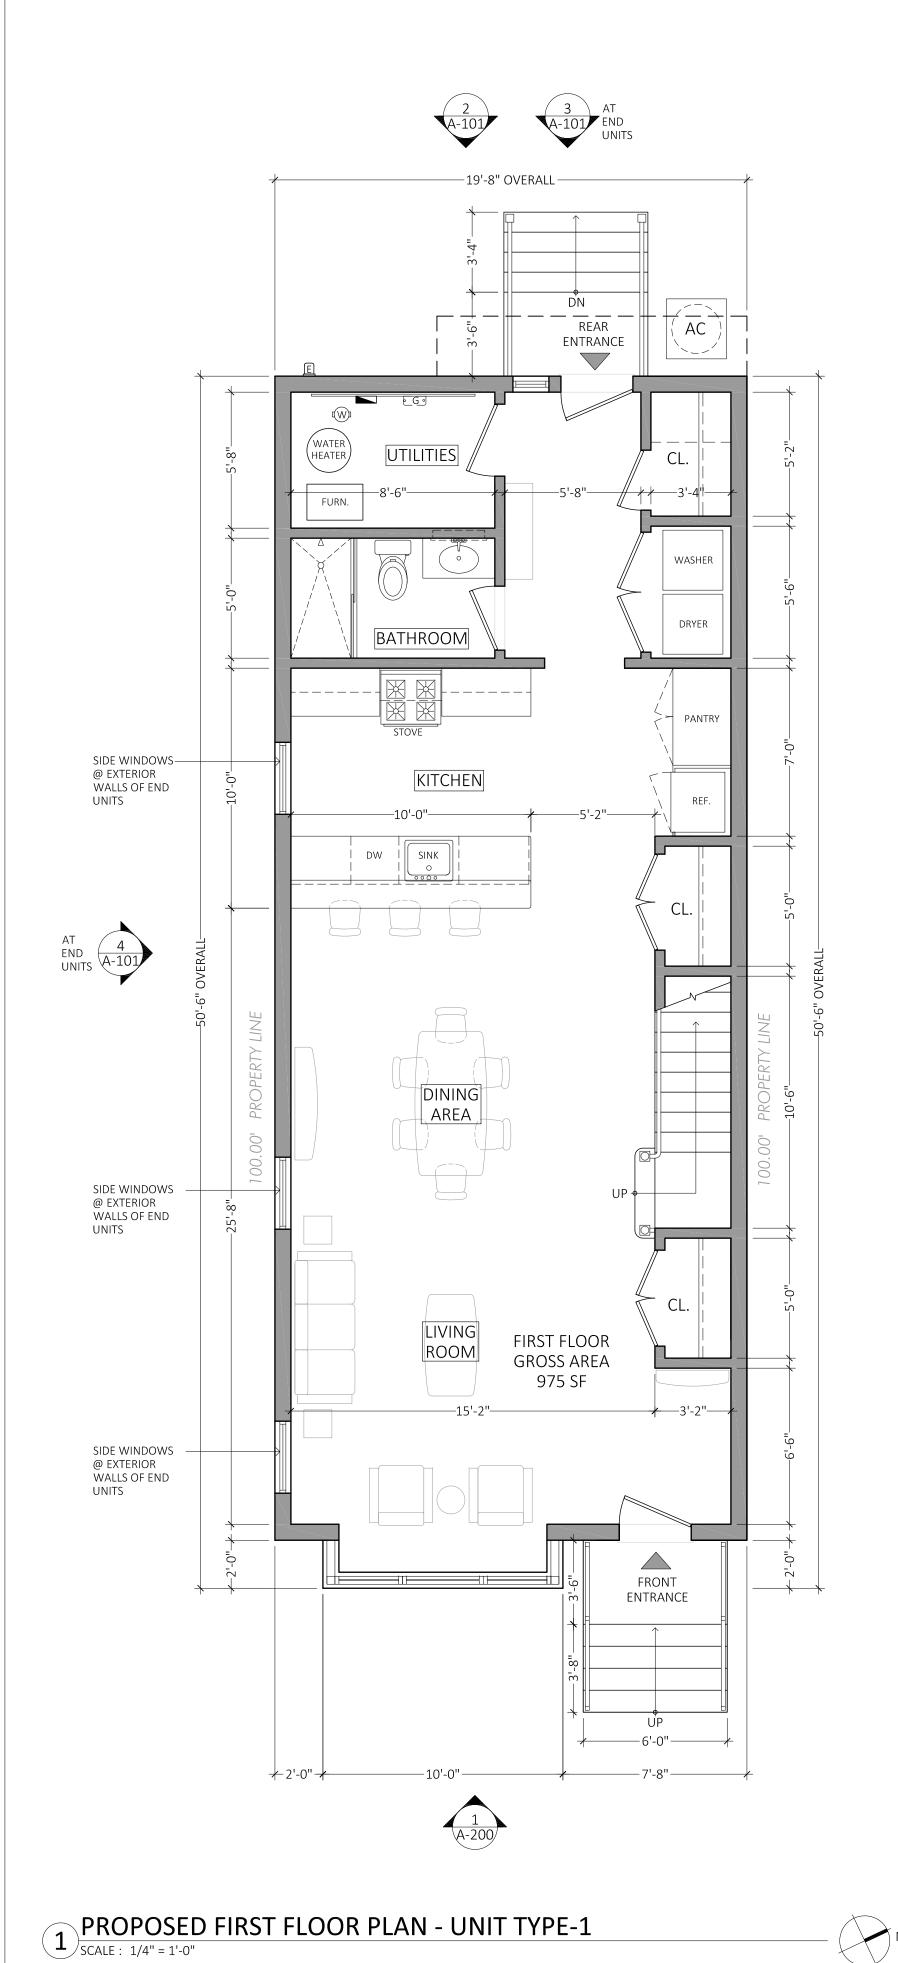137 Lake Road Va**ll**ey Cottage, NY 10989

Civil Engineer

JENNE ASSOCIATES, LLC

Consulting Engineers
35 Gates Avenue
Warren, NJ 07059

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Drawing Title

UNIT TYPE #1 PROPOSED FLOOR PLANS

Drawing No.

A-100


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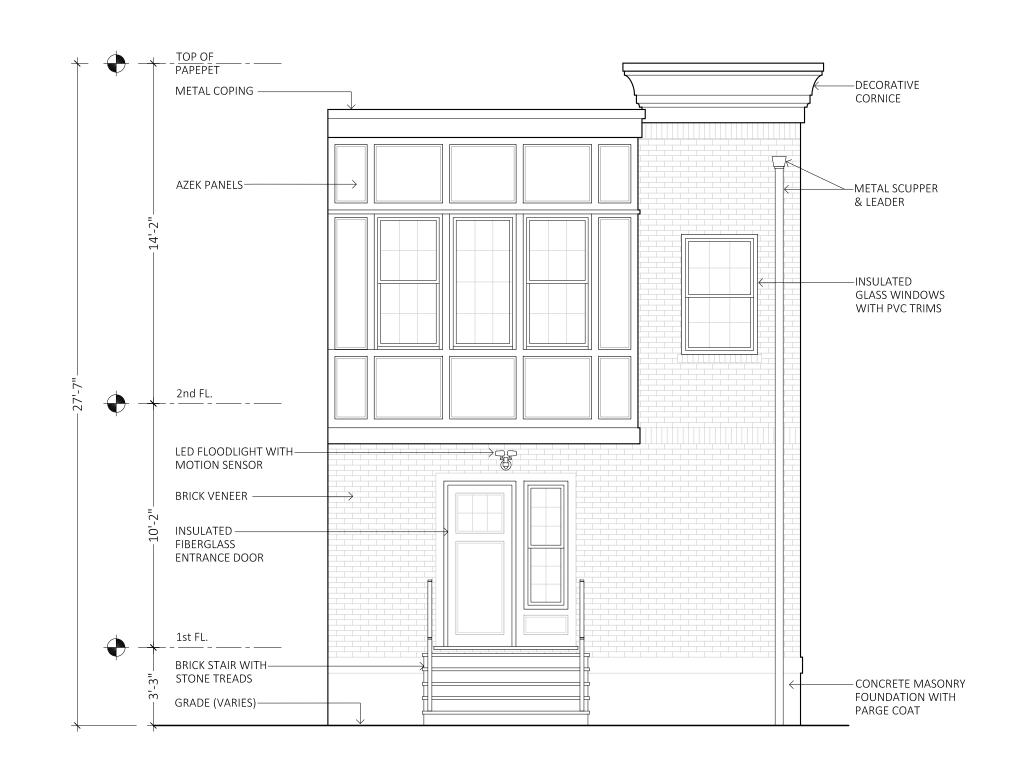
NS/MM

PROPOSED SECOND FLOOR PLAN - UNIT TYPE-1

SCALE: 1/4" = 1'-0"





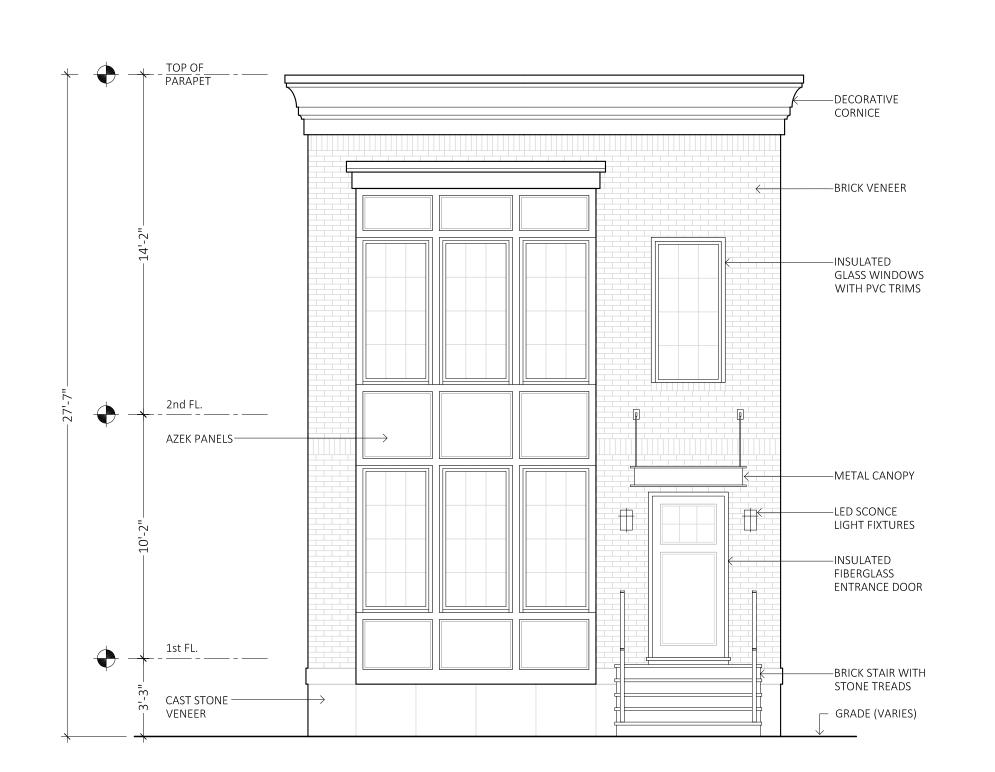

TYPICAL FRONT ELEVATION - UNIT TYPE-1


SCALE: 1/4" = 1'-0"

TYPICAL REAR ELEVATION - UNIT TYPE-1

SCALE: 1/4" = 1'-0"

REAR ELEVATION AT END UNITS - UNIT TYPE-1

SCALE: 1/4" = 1'-0"

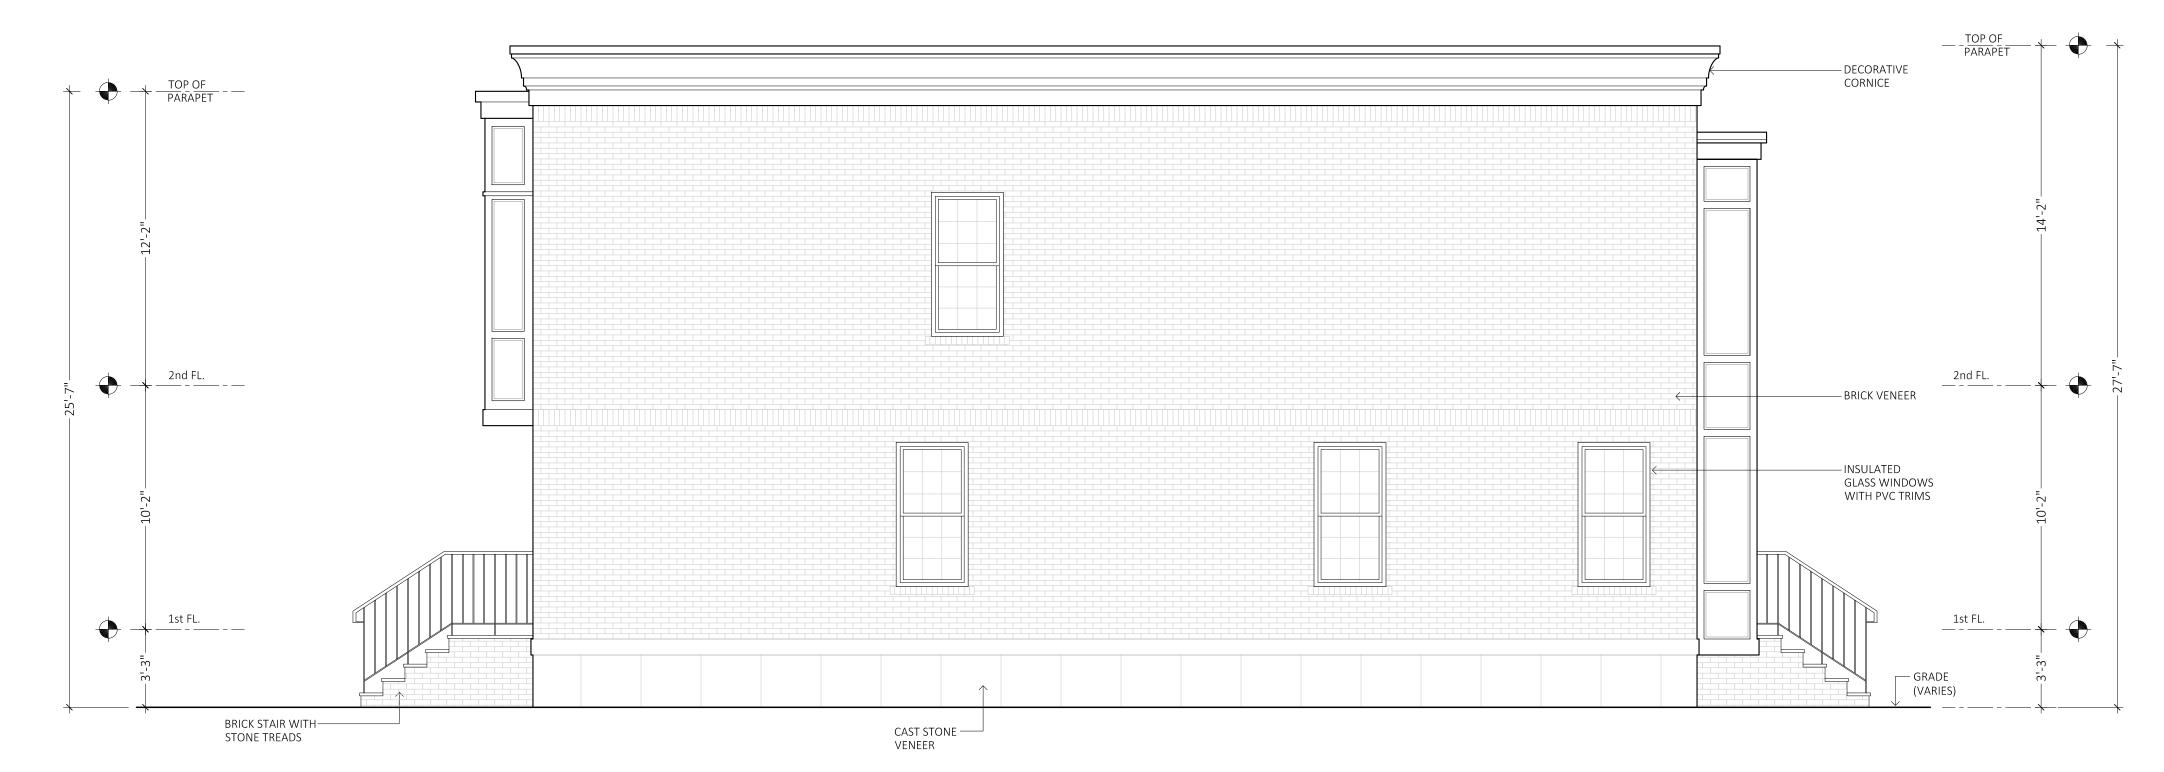

SIDE ELEVATION AT NORTH & SOUTH - UNIT TYPE-1

SCALE: 1/4" = 1'-0"

DATE	ISSUE	DESCRIPTION
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CASAS DEL RIO

CITY OF CAMDEN, NJ

CAMDEN LUTHERAN HOUSING INC.

Va**l**ley Cottage, NY 10989

JENNE

ASSOCIATES, LLC
Consulting Engineers
35 Gates Avenue
Warren, NJ 07059

Architect

Civil Engineer

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Project

CASAS DEL RIO
CAMDEN LUTHERAN HOUSING INC.
NORTH CAMDEN, NJ

Drawing Title

UNIT TYPE #1 PROPOSED BUILDING ELEVATIONS

Drawing No.


A-101

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Project No.
23-014

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CAST STONE VENEER

UNIT #1 - FRONT ELEVATION

SCALE: 3/8" = 1'-0"

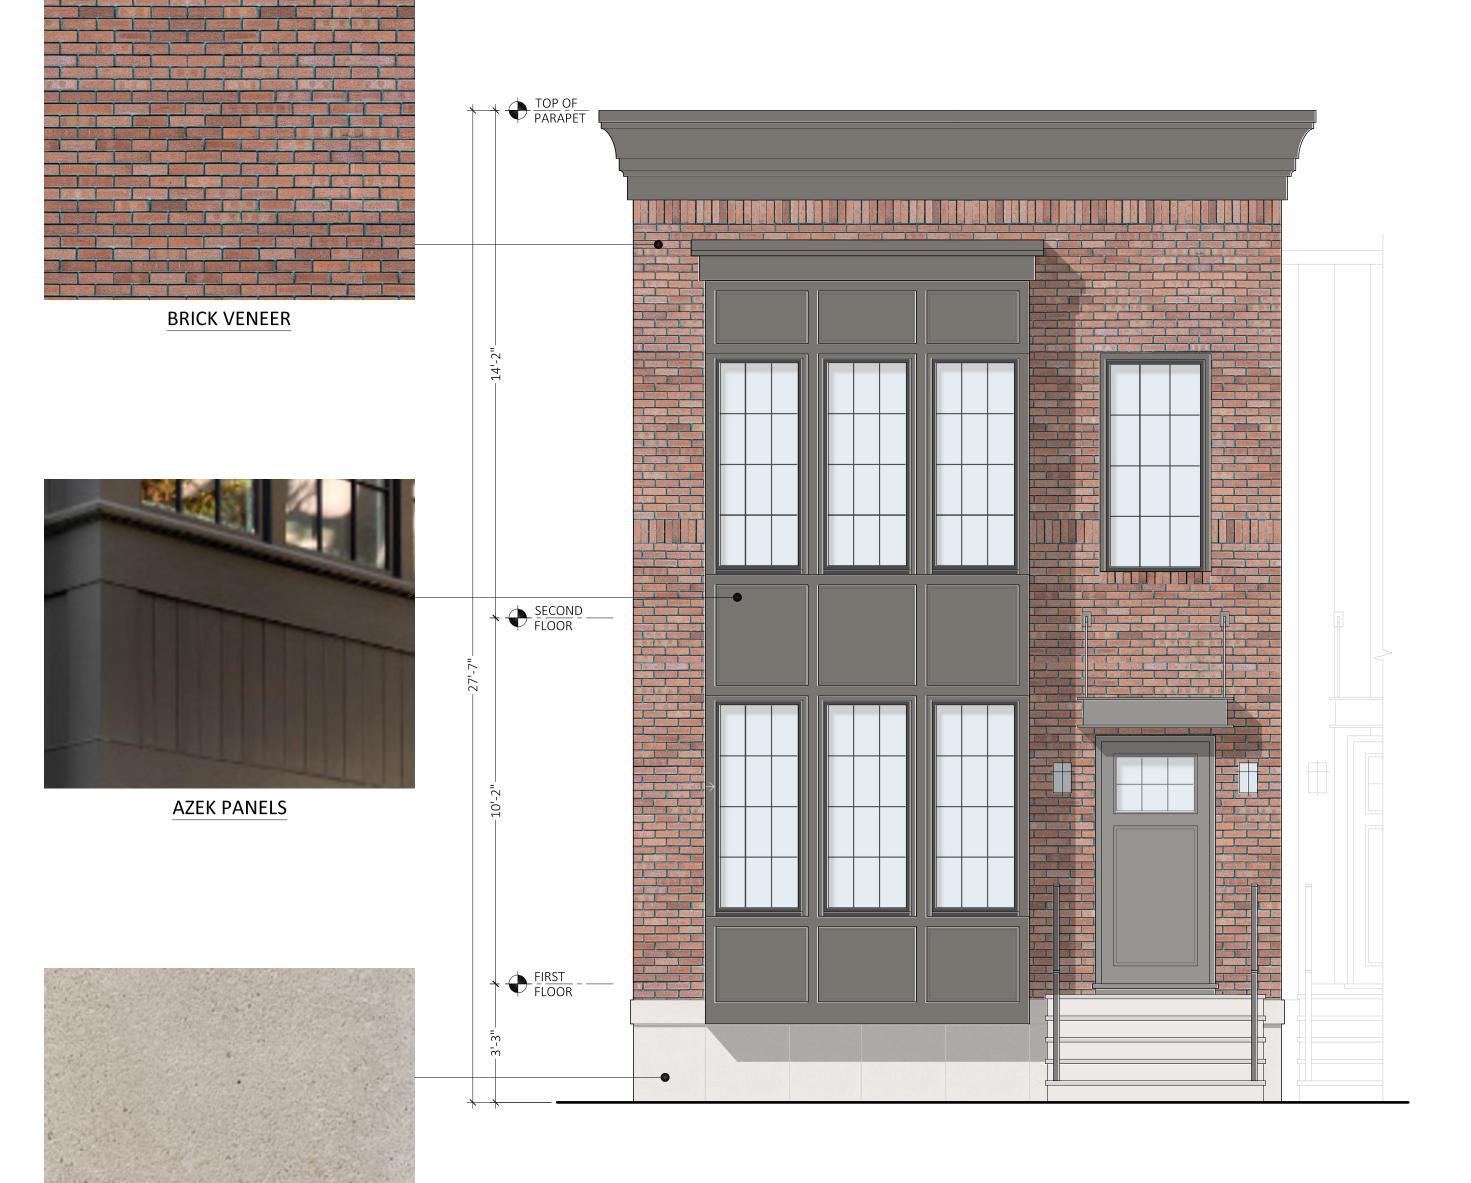

2 UNIT #1 - REAR ELEVATION
SCALE: 3/8" = 1'-0"



Archite

Milla Architecture Studio
137 Lake Road
Valley Cottage, NY 10989

Civil Engineer

JENNE ASSOCIATES, LLC Consulting Engineers 35 Gates Avenue Warren, NJ 07059

DATE	ISSUE	DESCRIPTION
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CASAS DEL RIO CAMDEN LUTHERAN HOUSING INC. NORTH CAMDEN, NJ

Drawing Title

UNIT TYPE #1 PROPOSED BUILDING MATERIALS

Drawing No.


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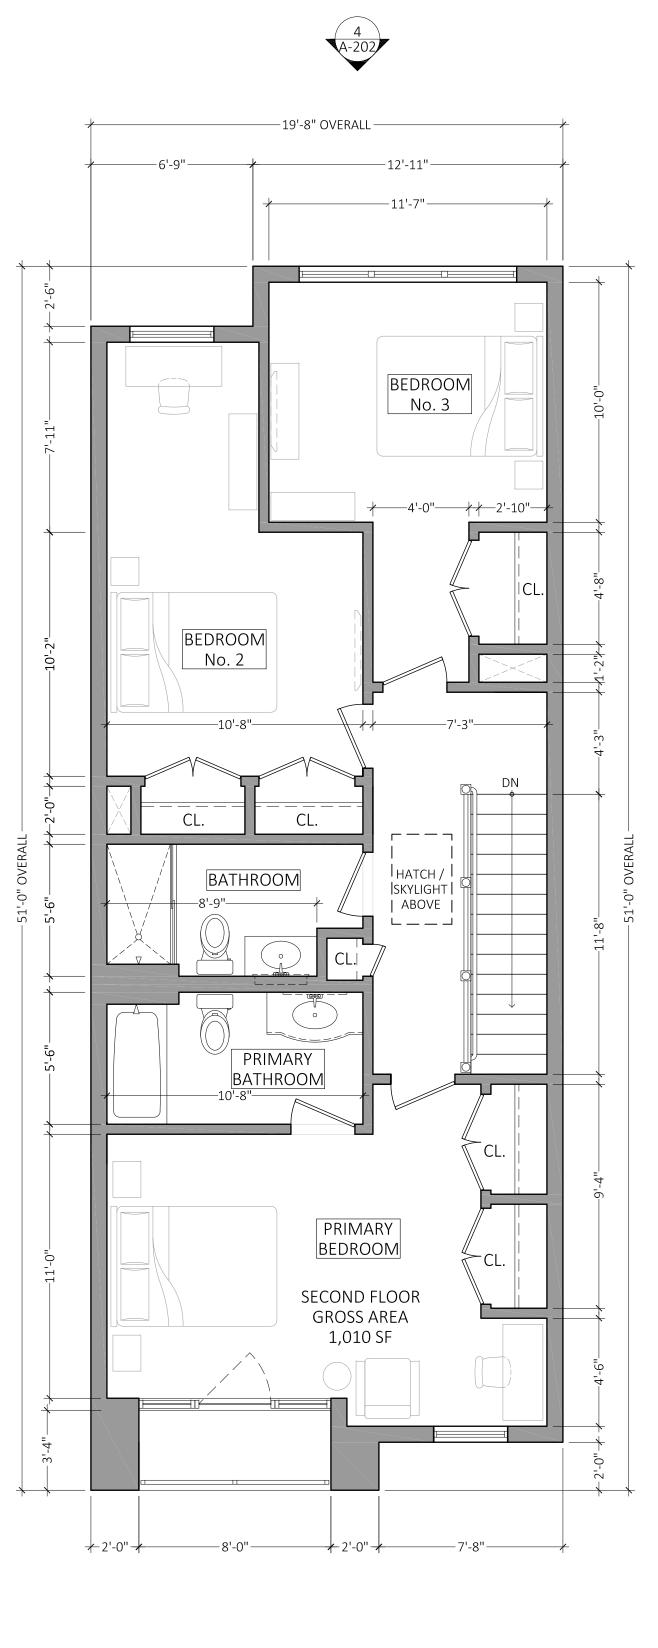
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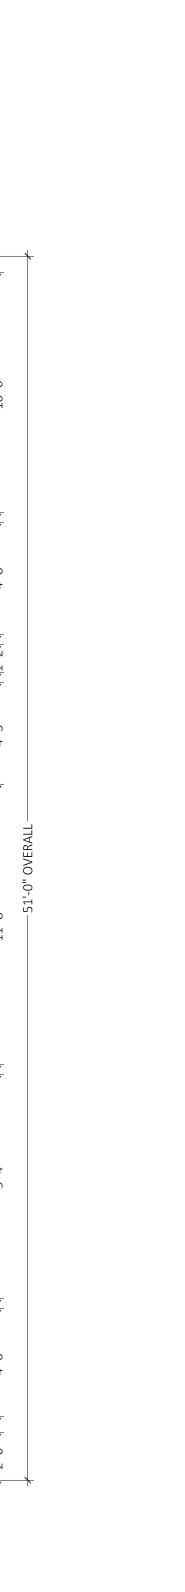
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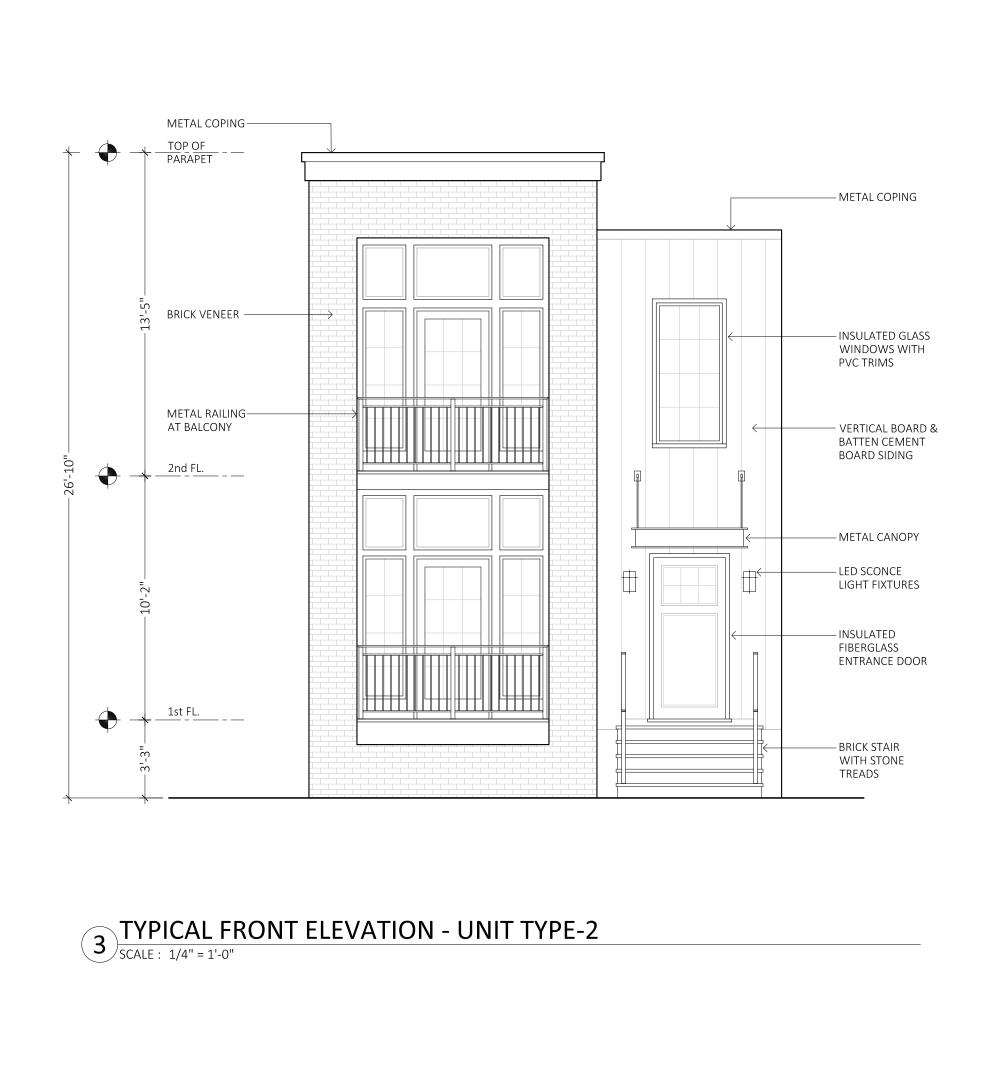
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TYPICAL REAR ELEVATION - UNIT TYPE-2

SCALE: 1/4" = 1'-0"



Civil Engineer

CLH NORTH CAMDEN

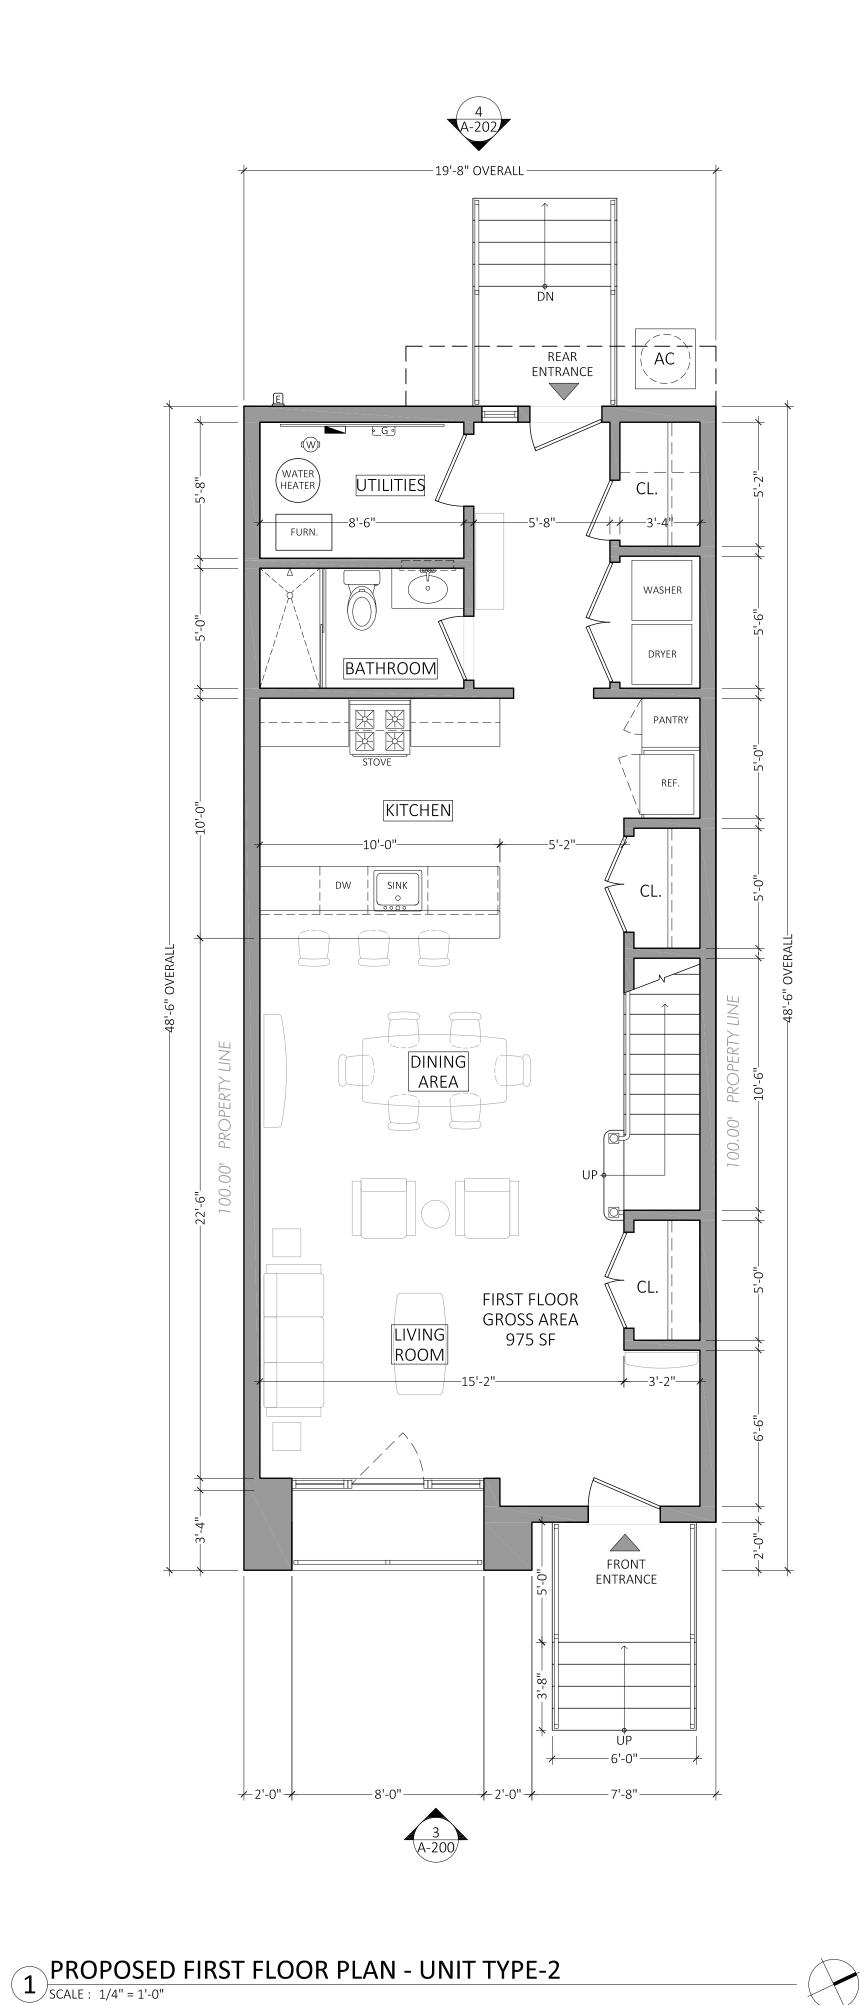CASAS DEL RIO

CITY OF CAMDEN, NJ

CAMDEN LUTHERAN HOUSING INC.

Valley Cottage, NY 10989

JENNE

ASSOCIATES, LLC

Consulting Engineers 35 Gates Avenue Warren, NJ 07059

DATE ISSUE DESCRIPTION 06/28/24 1 PLANNING BD. SUBMISSION

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CASAS DEL RIO CAMDEN LUTHERAN HOUSING INC. NORTH CAMDEN, NJ

Drawing Title

UNIT TYPE #2 PROPOSED FLOOR PLANS, & ELEVATIONS

Drawing No.

A-200

MICHAEL I. MILLA Project No. 23-014 AS NOTED

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2 UNIT #1 - REAR ELEVATION
SCALE: 3/8" = 1'-0"



137 Lake Road Va**ll**ey Cottage, NY 10989

Civil Engineer

JENNE ASSOCIATES, LLC Consulting Engineers 35 Gates Avenue Warren, NJ 07059

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06/28/24	1	PLANNING BD. SUBMISSION

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Drawing Title


UNIT TYPE #2 PROPOSED BUILDING **MATERIALS**

Drawing No.


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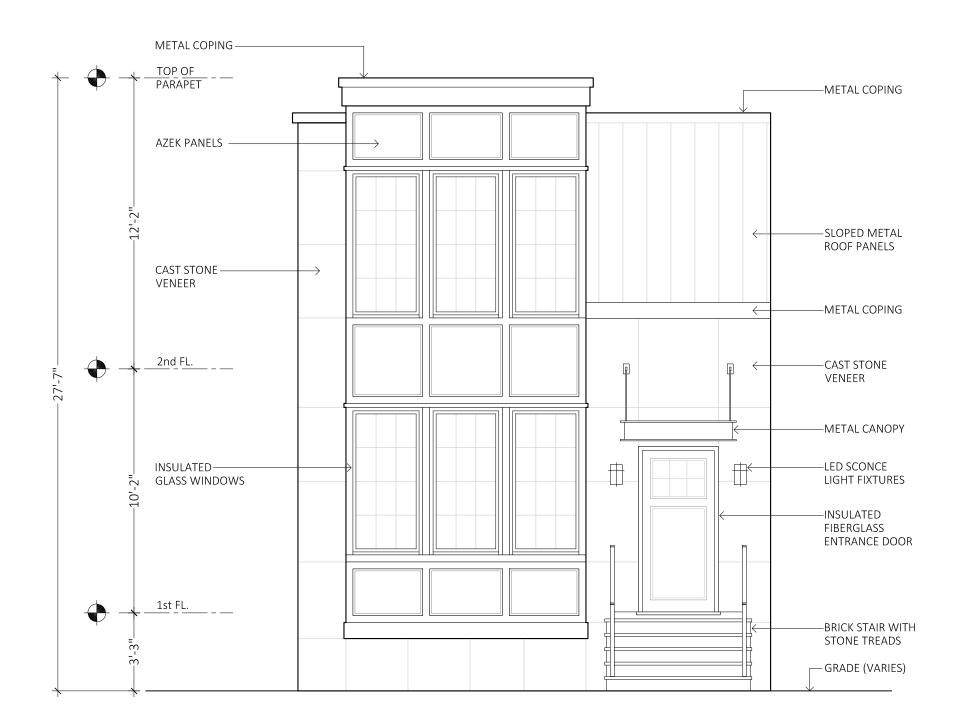
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TYPICAL FRONT ELEVATION - UNIT TYPE-3

SCALE: 1/4" = 1'-0"

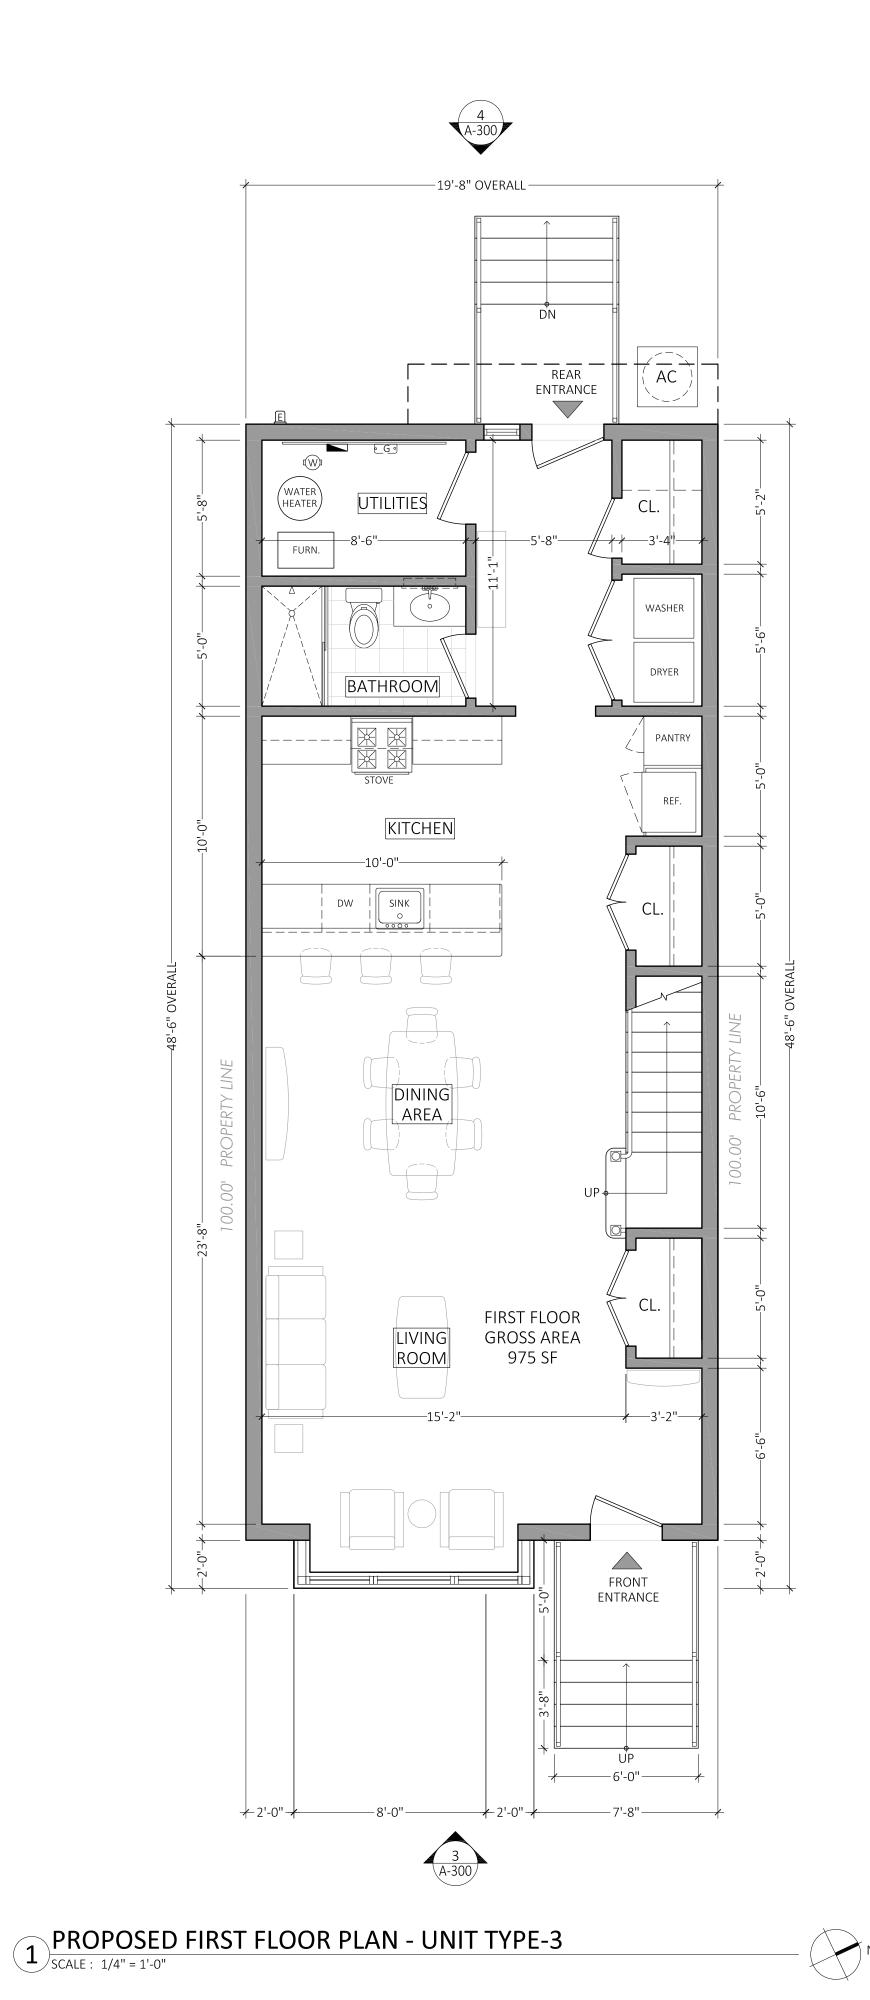

TYPICAL REAR ELEVATION - UNIT TYPE-3

SCALE: 1/4" = 1'-0"

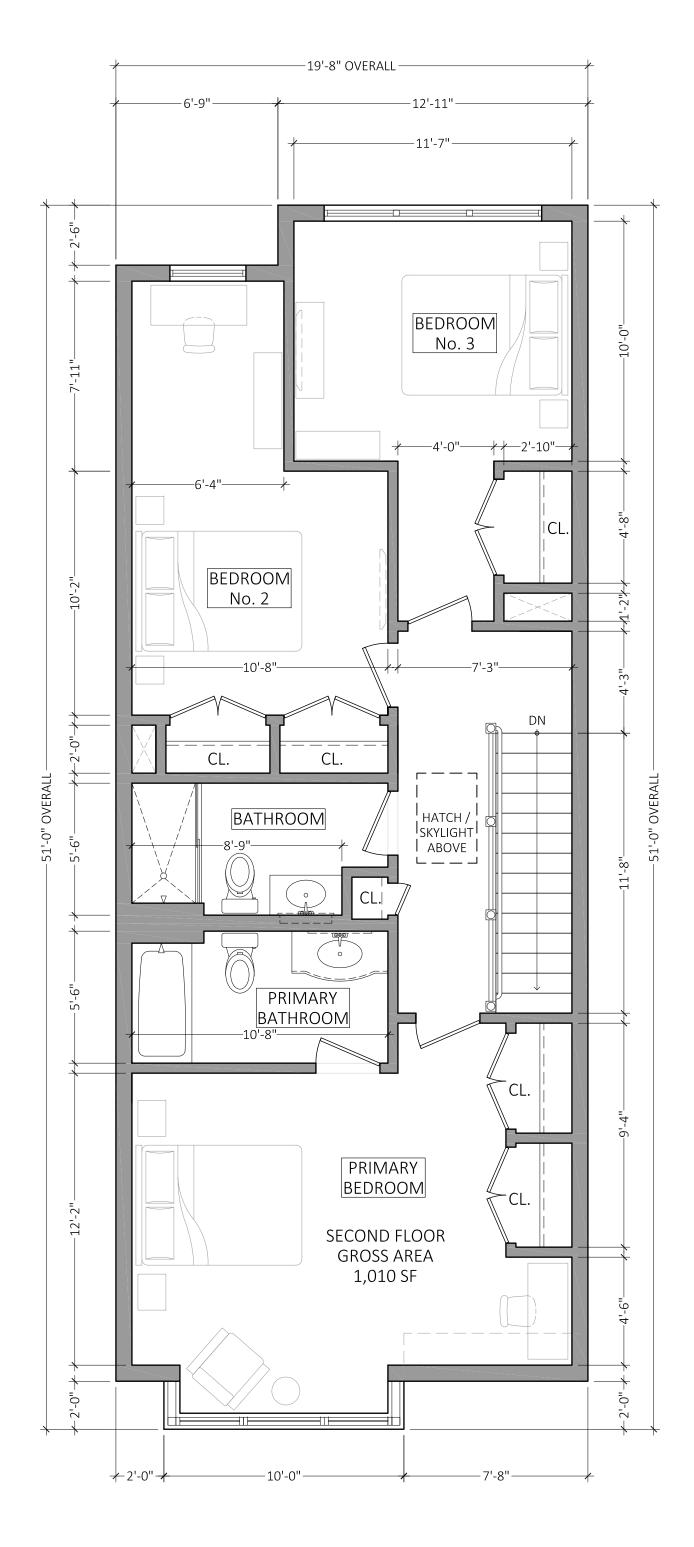DATE ISSUE DESCRIPTION

06/28/24 1 PLANNING BD. SUBMISSION

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CASAS DEL RIO

CITY OF CAMDEN, NJ

CAMDEN LUTHERAN HOUSING INC.

Civil Engineer

Va**l**ley Cottage, NY 10989

JENNE

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Consulting Engineers 35 Gates Avenue Warren, NJ 07059

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Project

CASAS DEL RIO
CAMDEN LUTHERAN HOUSING INC.
NORTH CAMDEN, NJ

Drawing Title

UNIT TYPE #3
PROPOSED
FLOOR PLANS,
& ELEVATIONS

Drawing No.

A-300

MICHAEL I. MILLA

Project No.
23-014

Scale
AS NOTED


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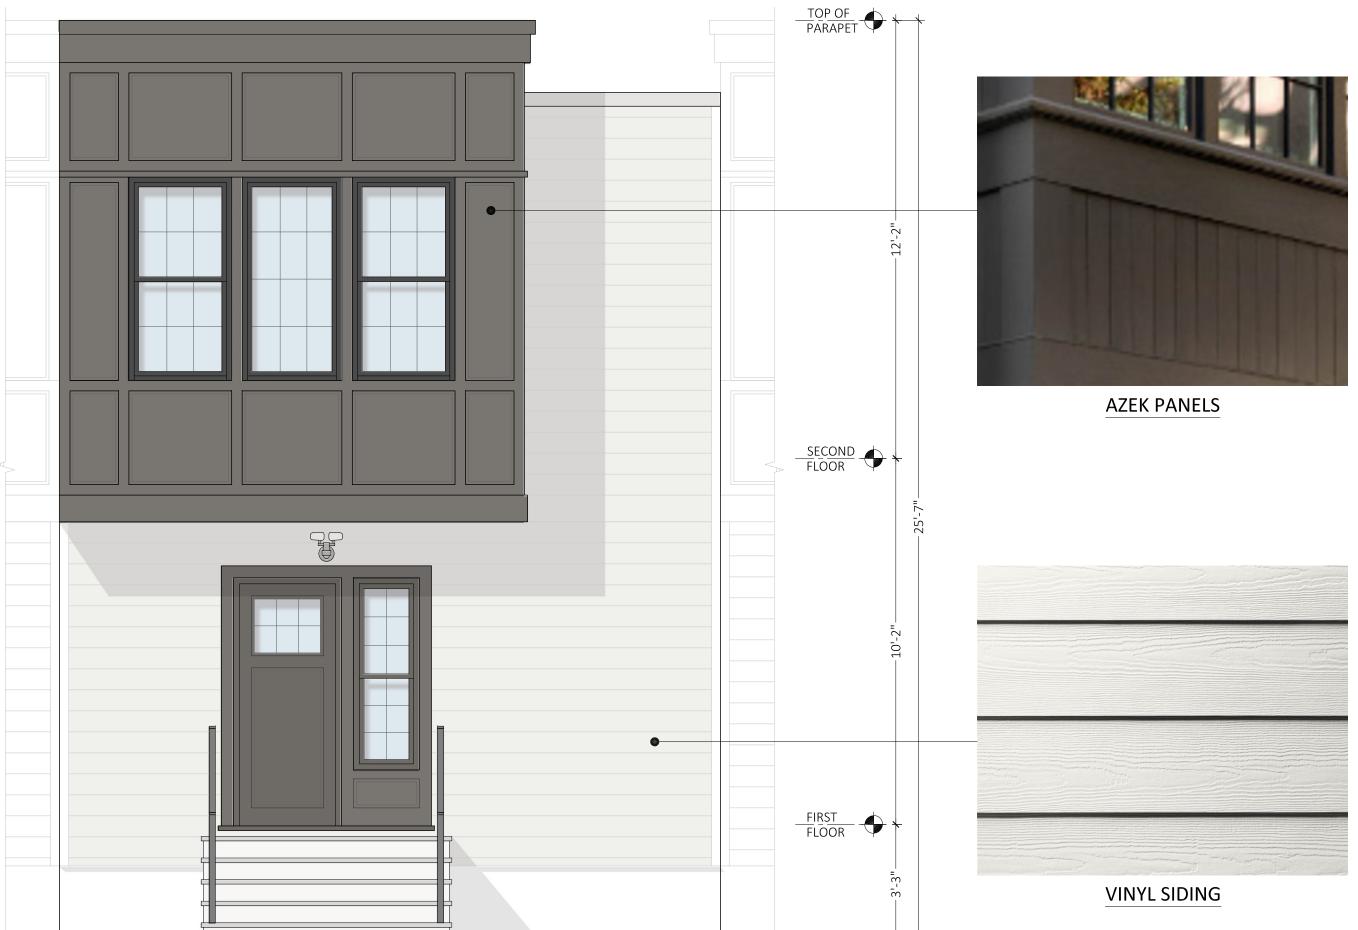
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PROPOSED SECOND FLOOR PLAN - UNIT TYPE-3

SCALE: 1/4" = 1'-0"





UNIT #3 - REAR ELEVATION

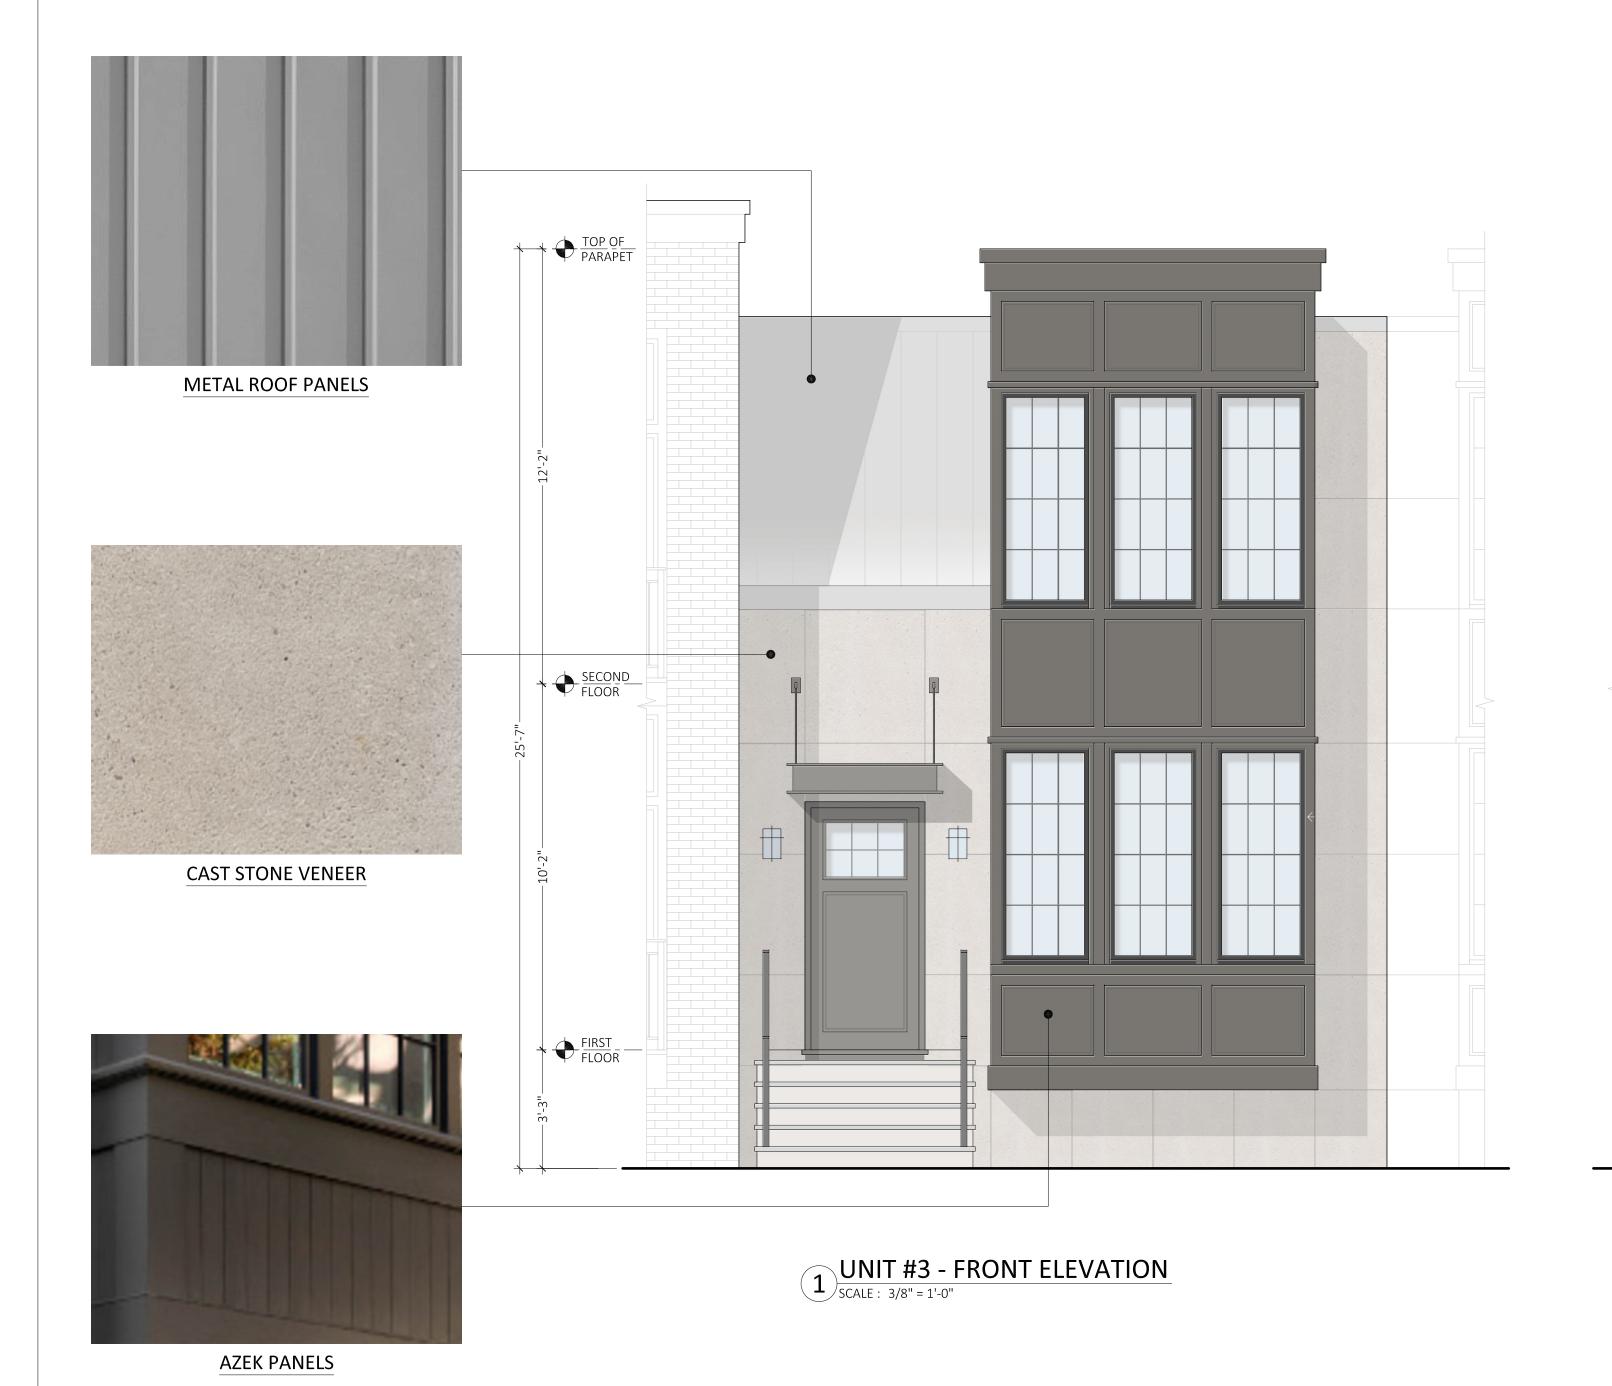SCALE: 3/8" = 1'-0"



CAMDEN LUTHERAN HOUSING INC.

Architect

Milla Architecture Studio
137 Lake Road
Valley Cottage, NY 10989

Civil Engineer

JENNE ASSOCIATES, LLC Consulting Engineers 35 Gates Avenue Warren, NJ 07059

DATE	ISSUE	DESCRIPTION
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Project

CASAS DEL RIO CAMDEN LUTHERAN HOUSING INC. NORTH CAMDEN, NJ

Drawing Title

UNIT TYPE #3
PROPOSED
BUILDING
MATERIALS

Drawing No.

A-301

MICHAEL I. MILLA

Project No.
23-014

Scale
AS NOTED

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